





WATER SUPPLY @ CBIL
 ALL APT RISERS 3/4" COPPER TAG/METAL NOS.

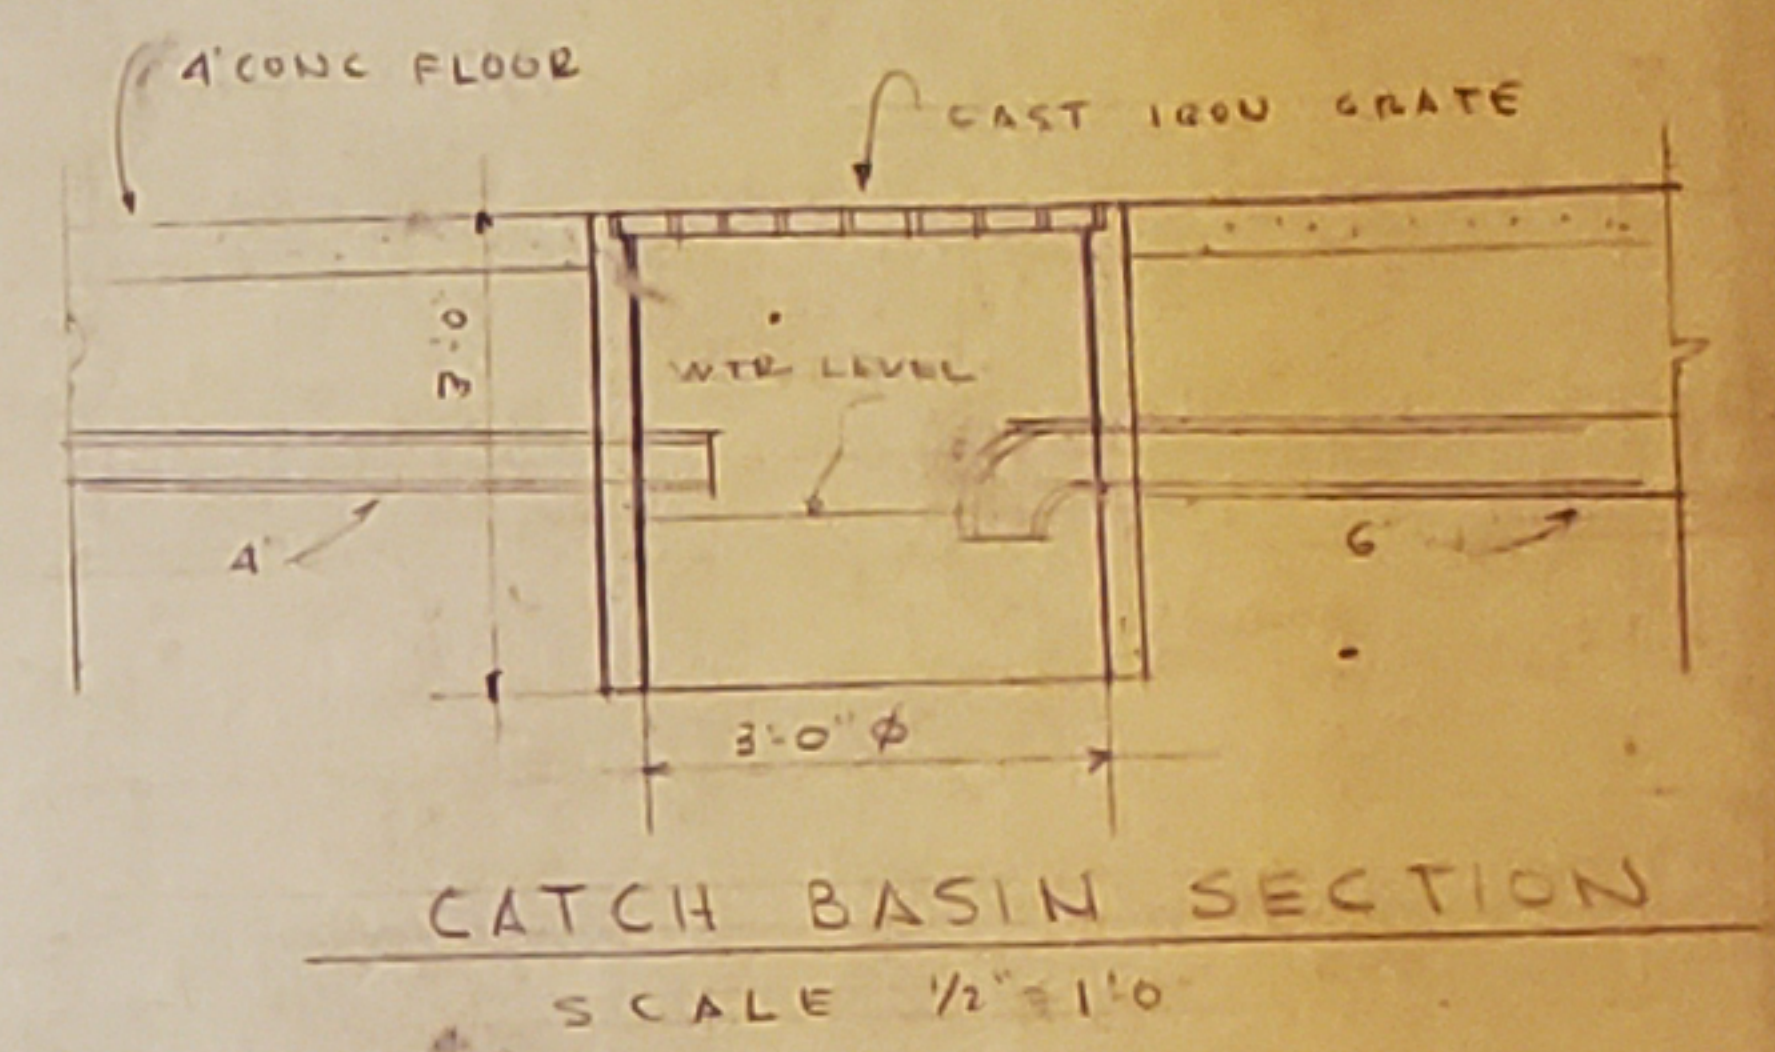

FOOTING SCHEDULE			
MARK	SIZE	REINFORCING	NO./BLDG
* A	6'9" X 6'9" X 14"	14 #5 EA WAY	3
* B	6'0" X 6'0" X 14"	10 #5 EA WAY	2
C	4'6" X 4'6" X 10"	8 #5 EA WAY	2
D	2'6" X 6'0" X 12"	7 #5 #15'6" CLAS	2
* E	6'2" X 6'2" X 14"	10 #5 EA WAY	1
F	3'6" X 3'6" X 10"	7 #5 EA WAY	2

PIER SCHEDULE			
MARK	SIZE	REINFORCING	NO./BLDG
C	3'6" X 3'6" X 9'6"	6 #5 EA FACE #2@12 TIES	4
D	2'6" X 2'0" X 9'6"	6 #5 EA FACE #2@12 TIES	2

NOTE: BEAMS, COLS & PRESTRESSED SLABS BY SPANCRETE CO.

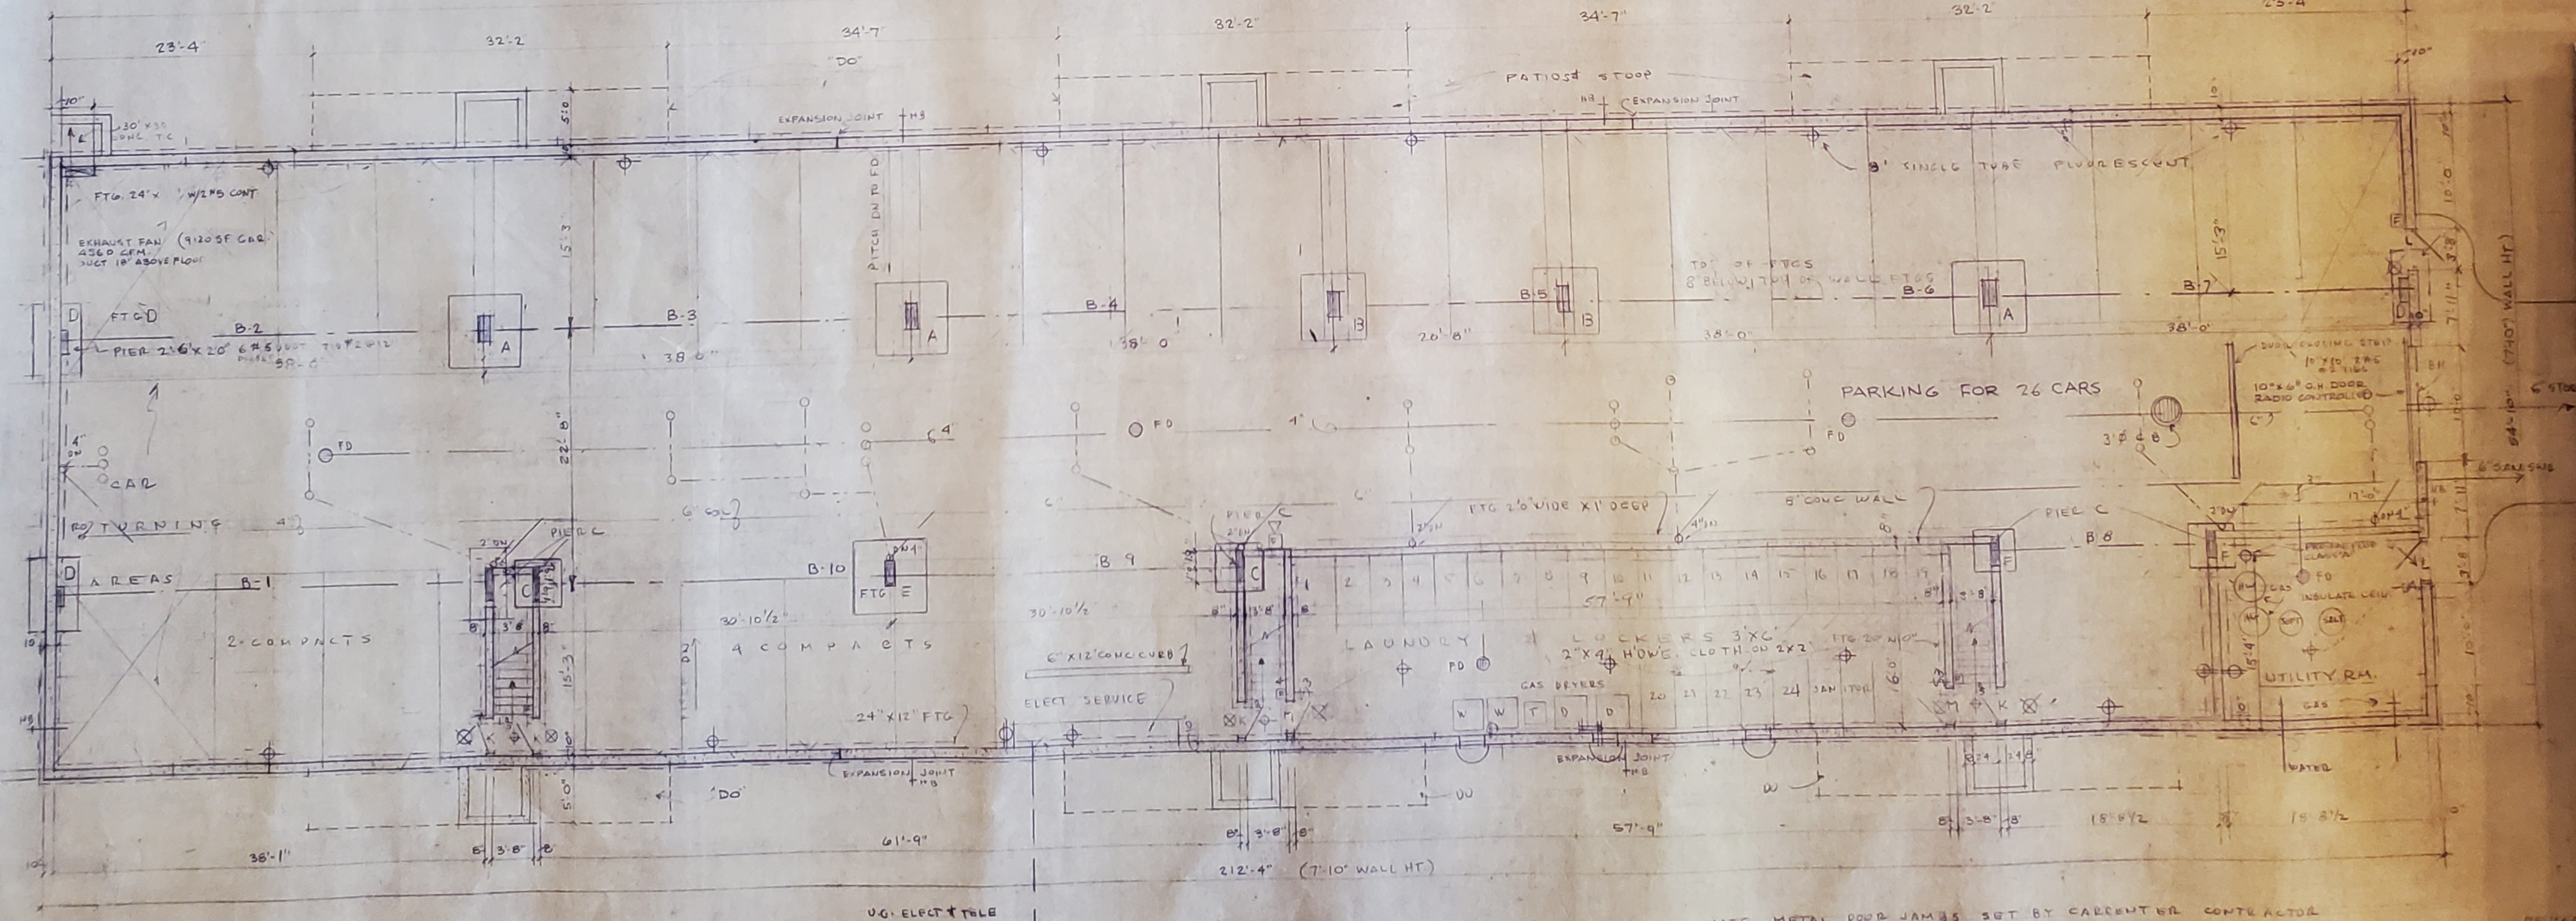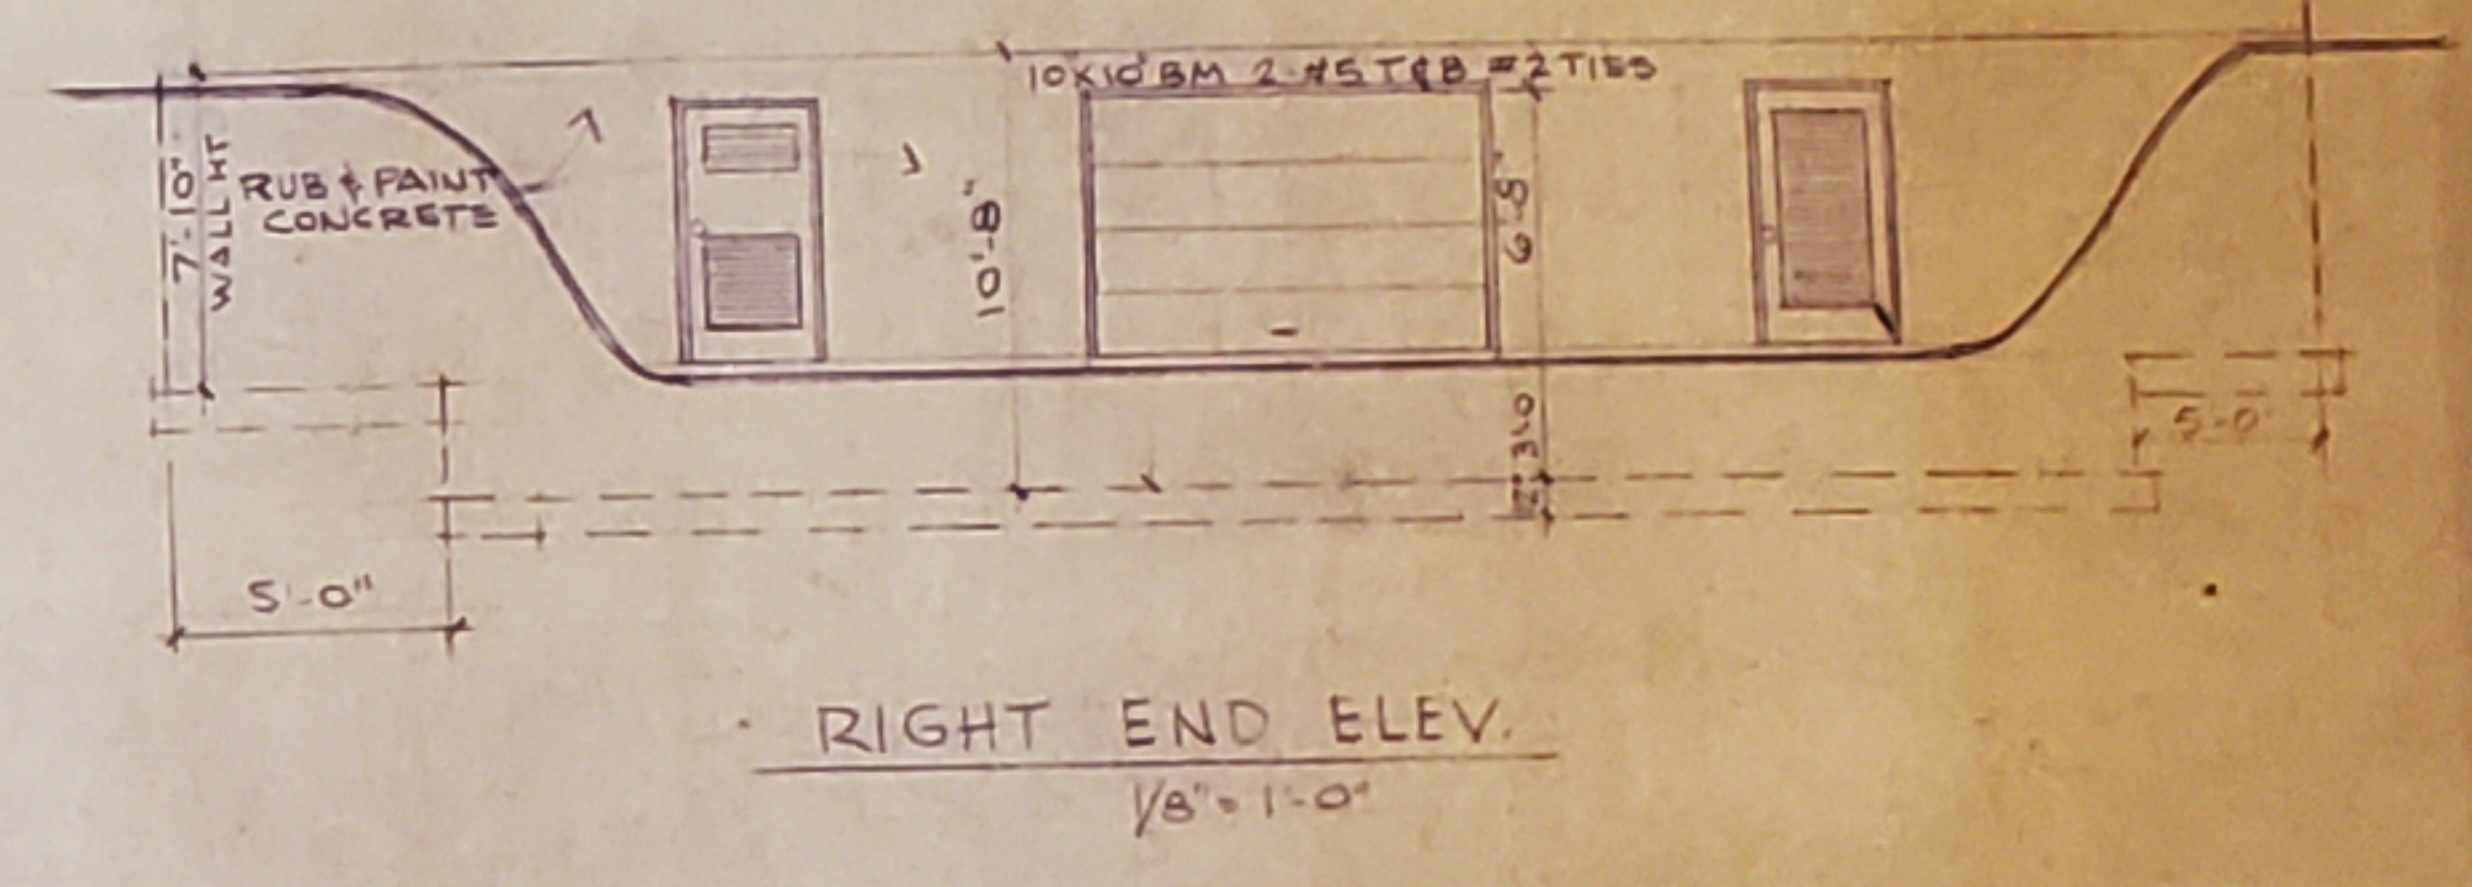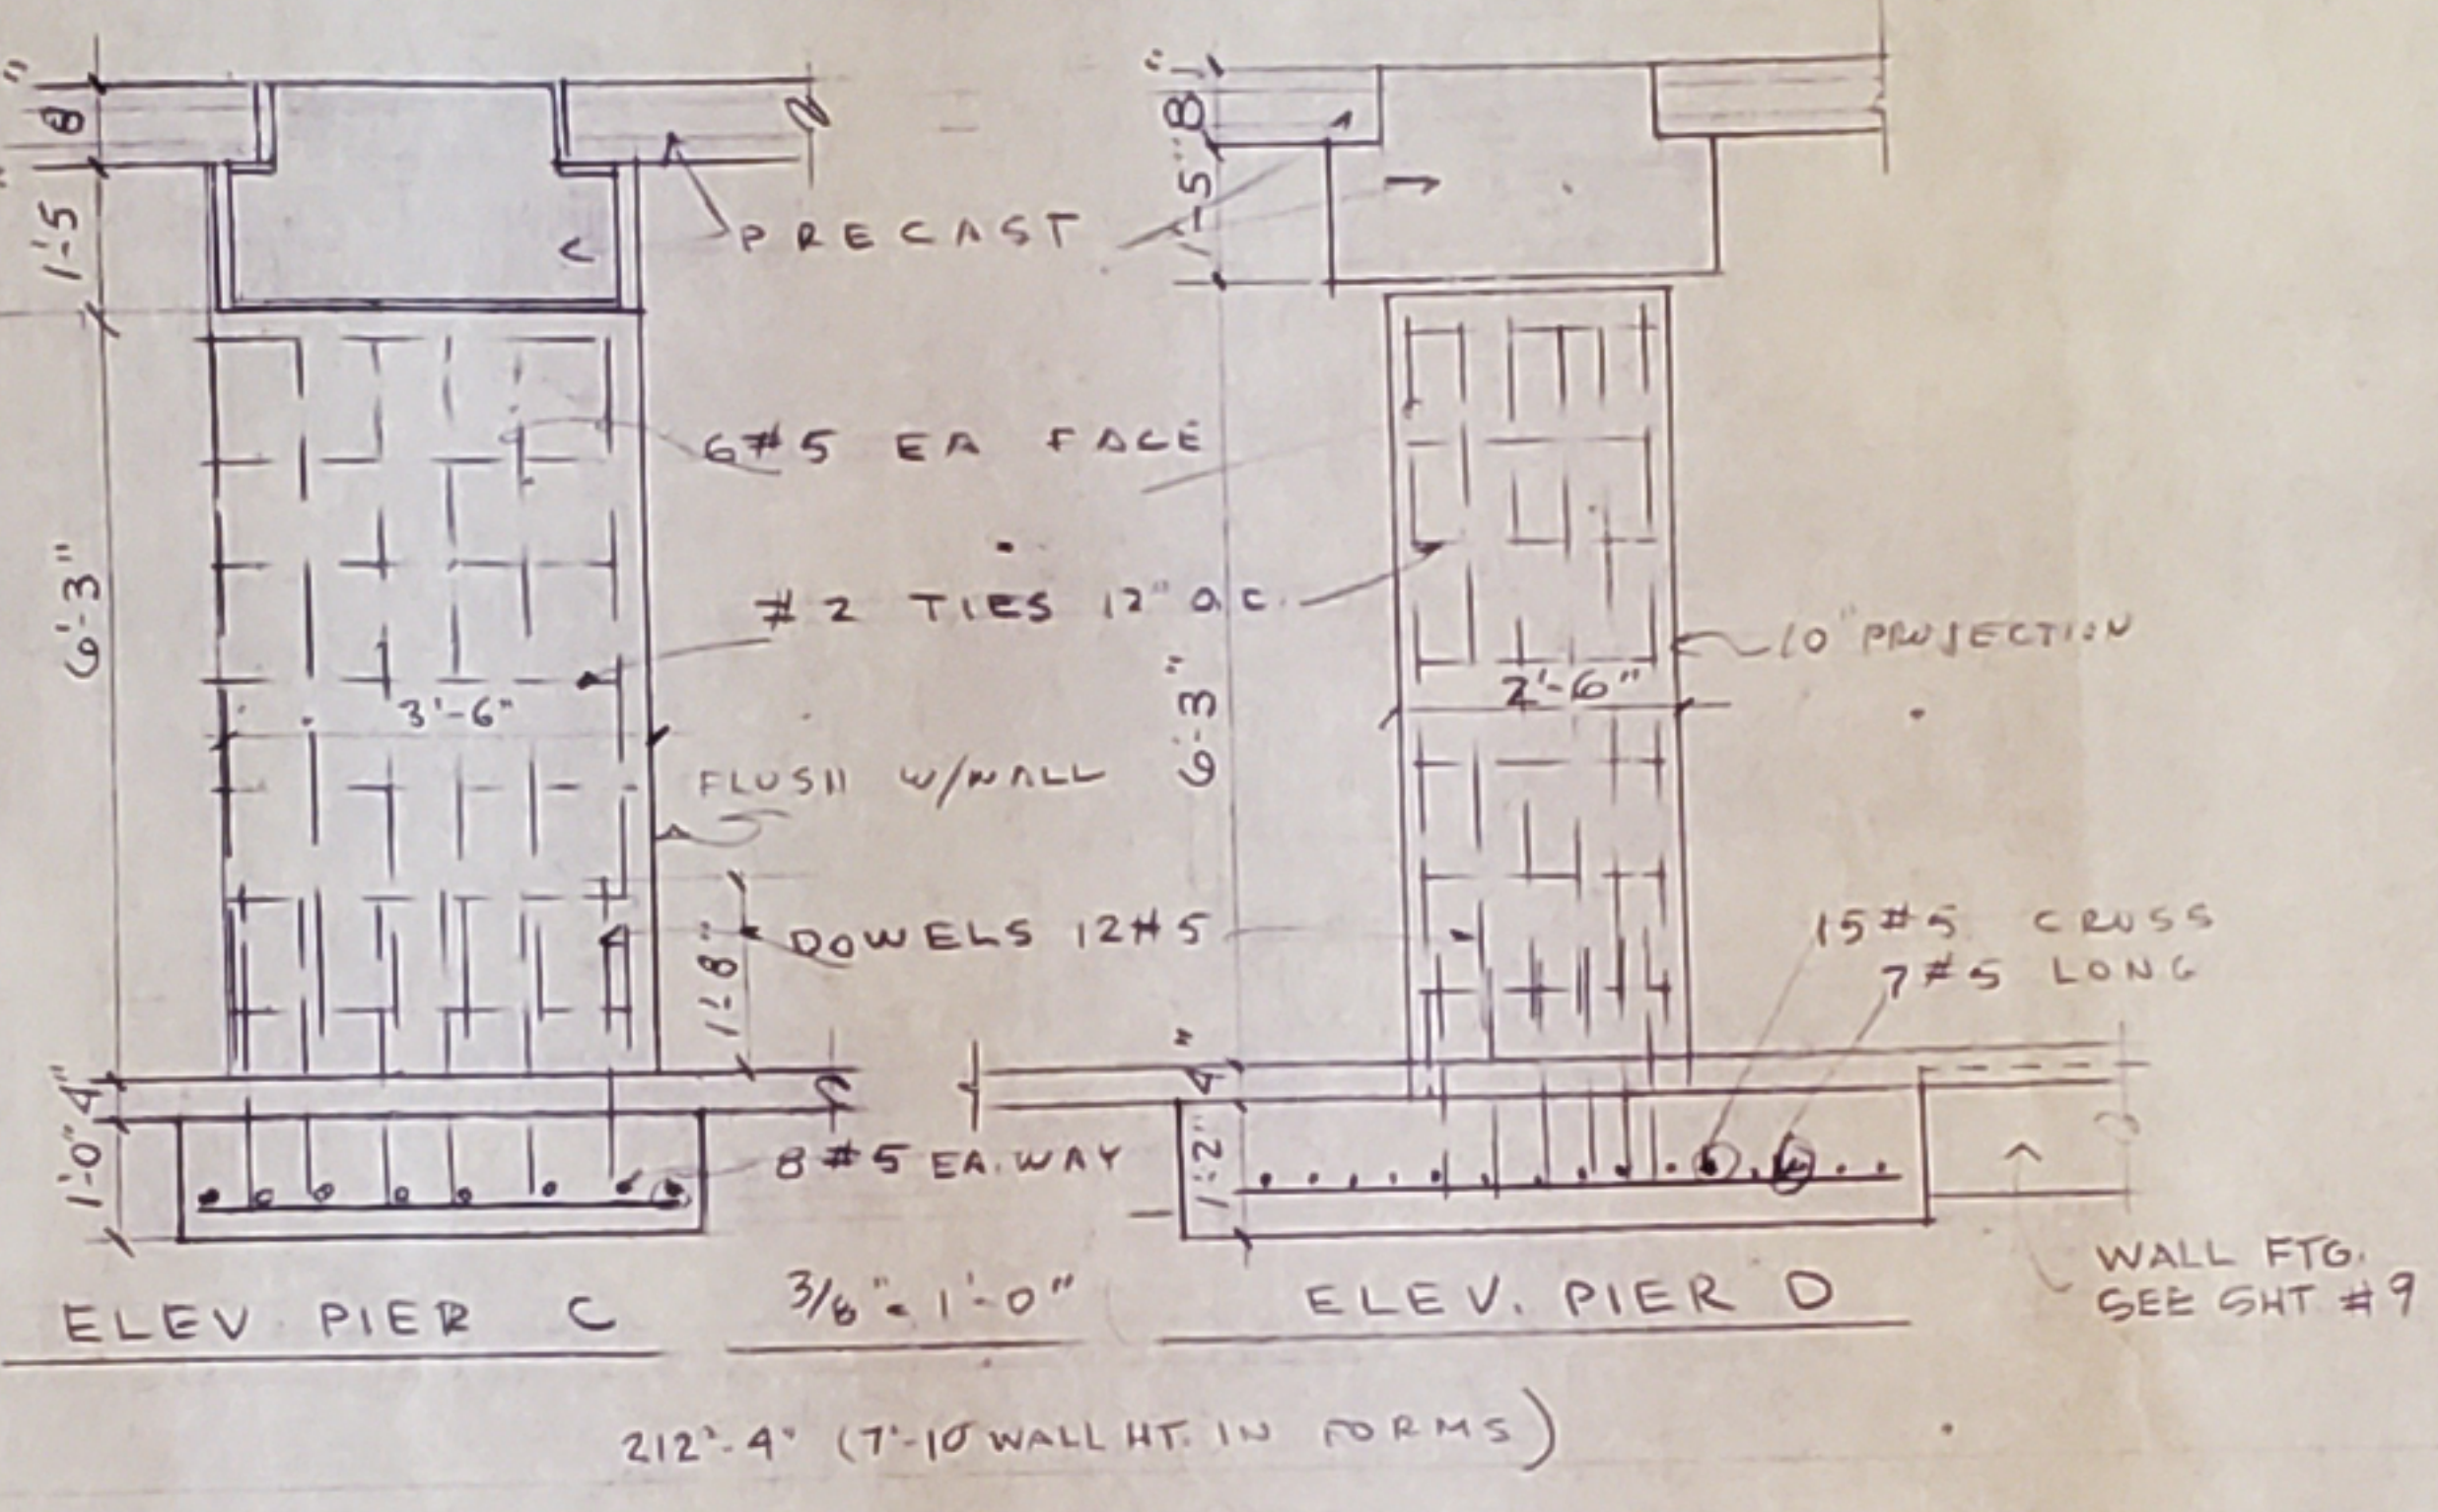


BASEMENT PLAN
 1/8" = 1'-0"



ROBERT STAUBER & ASSOCIATES
 ARCHITECTS-ENGINEERS
 MADISON, WISCONSIN

24 UNIT APT. BLDG. - 2 STOREY






REVISIONS			REVISIONS		
NO.	DATE	BY	NO.	DATE	BY

REVISIONS
 DRAWN
 APPROVED
 DATE
 7-14-68

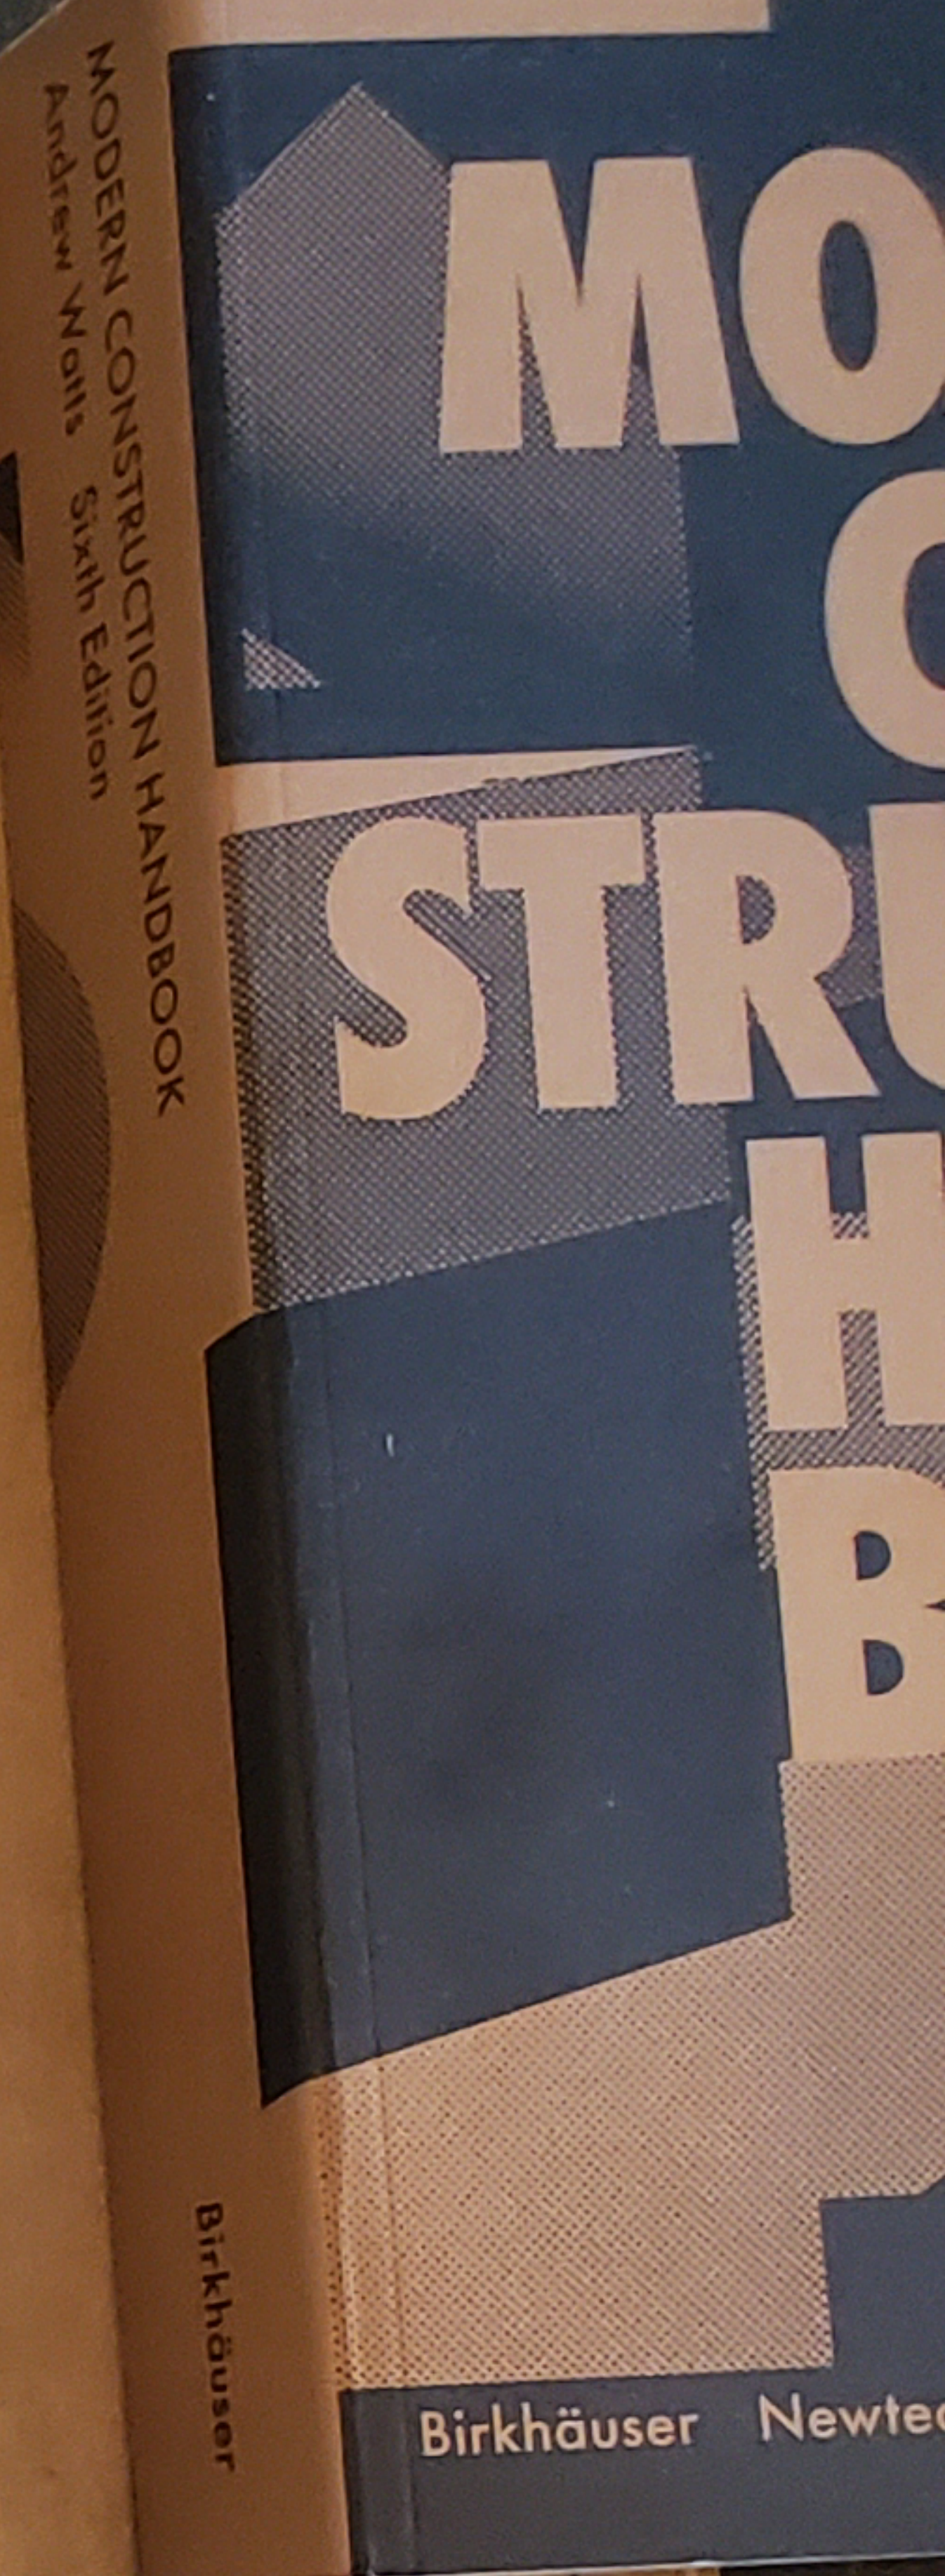

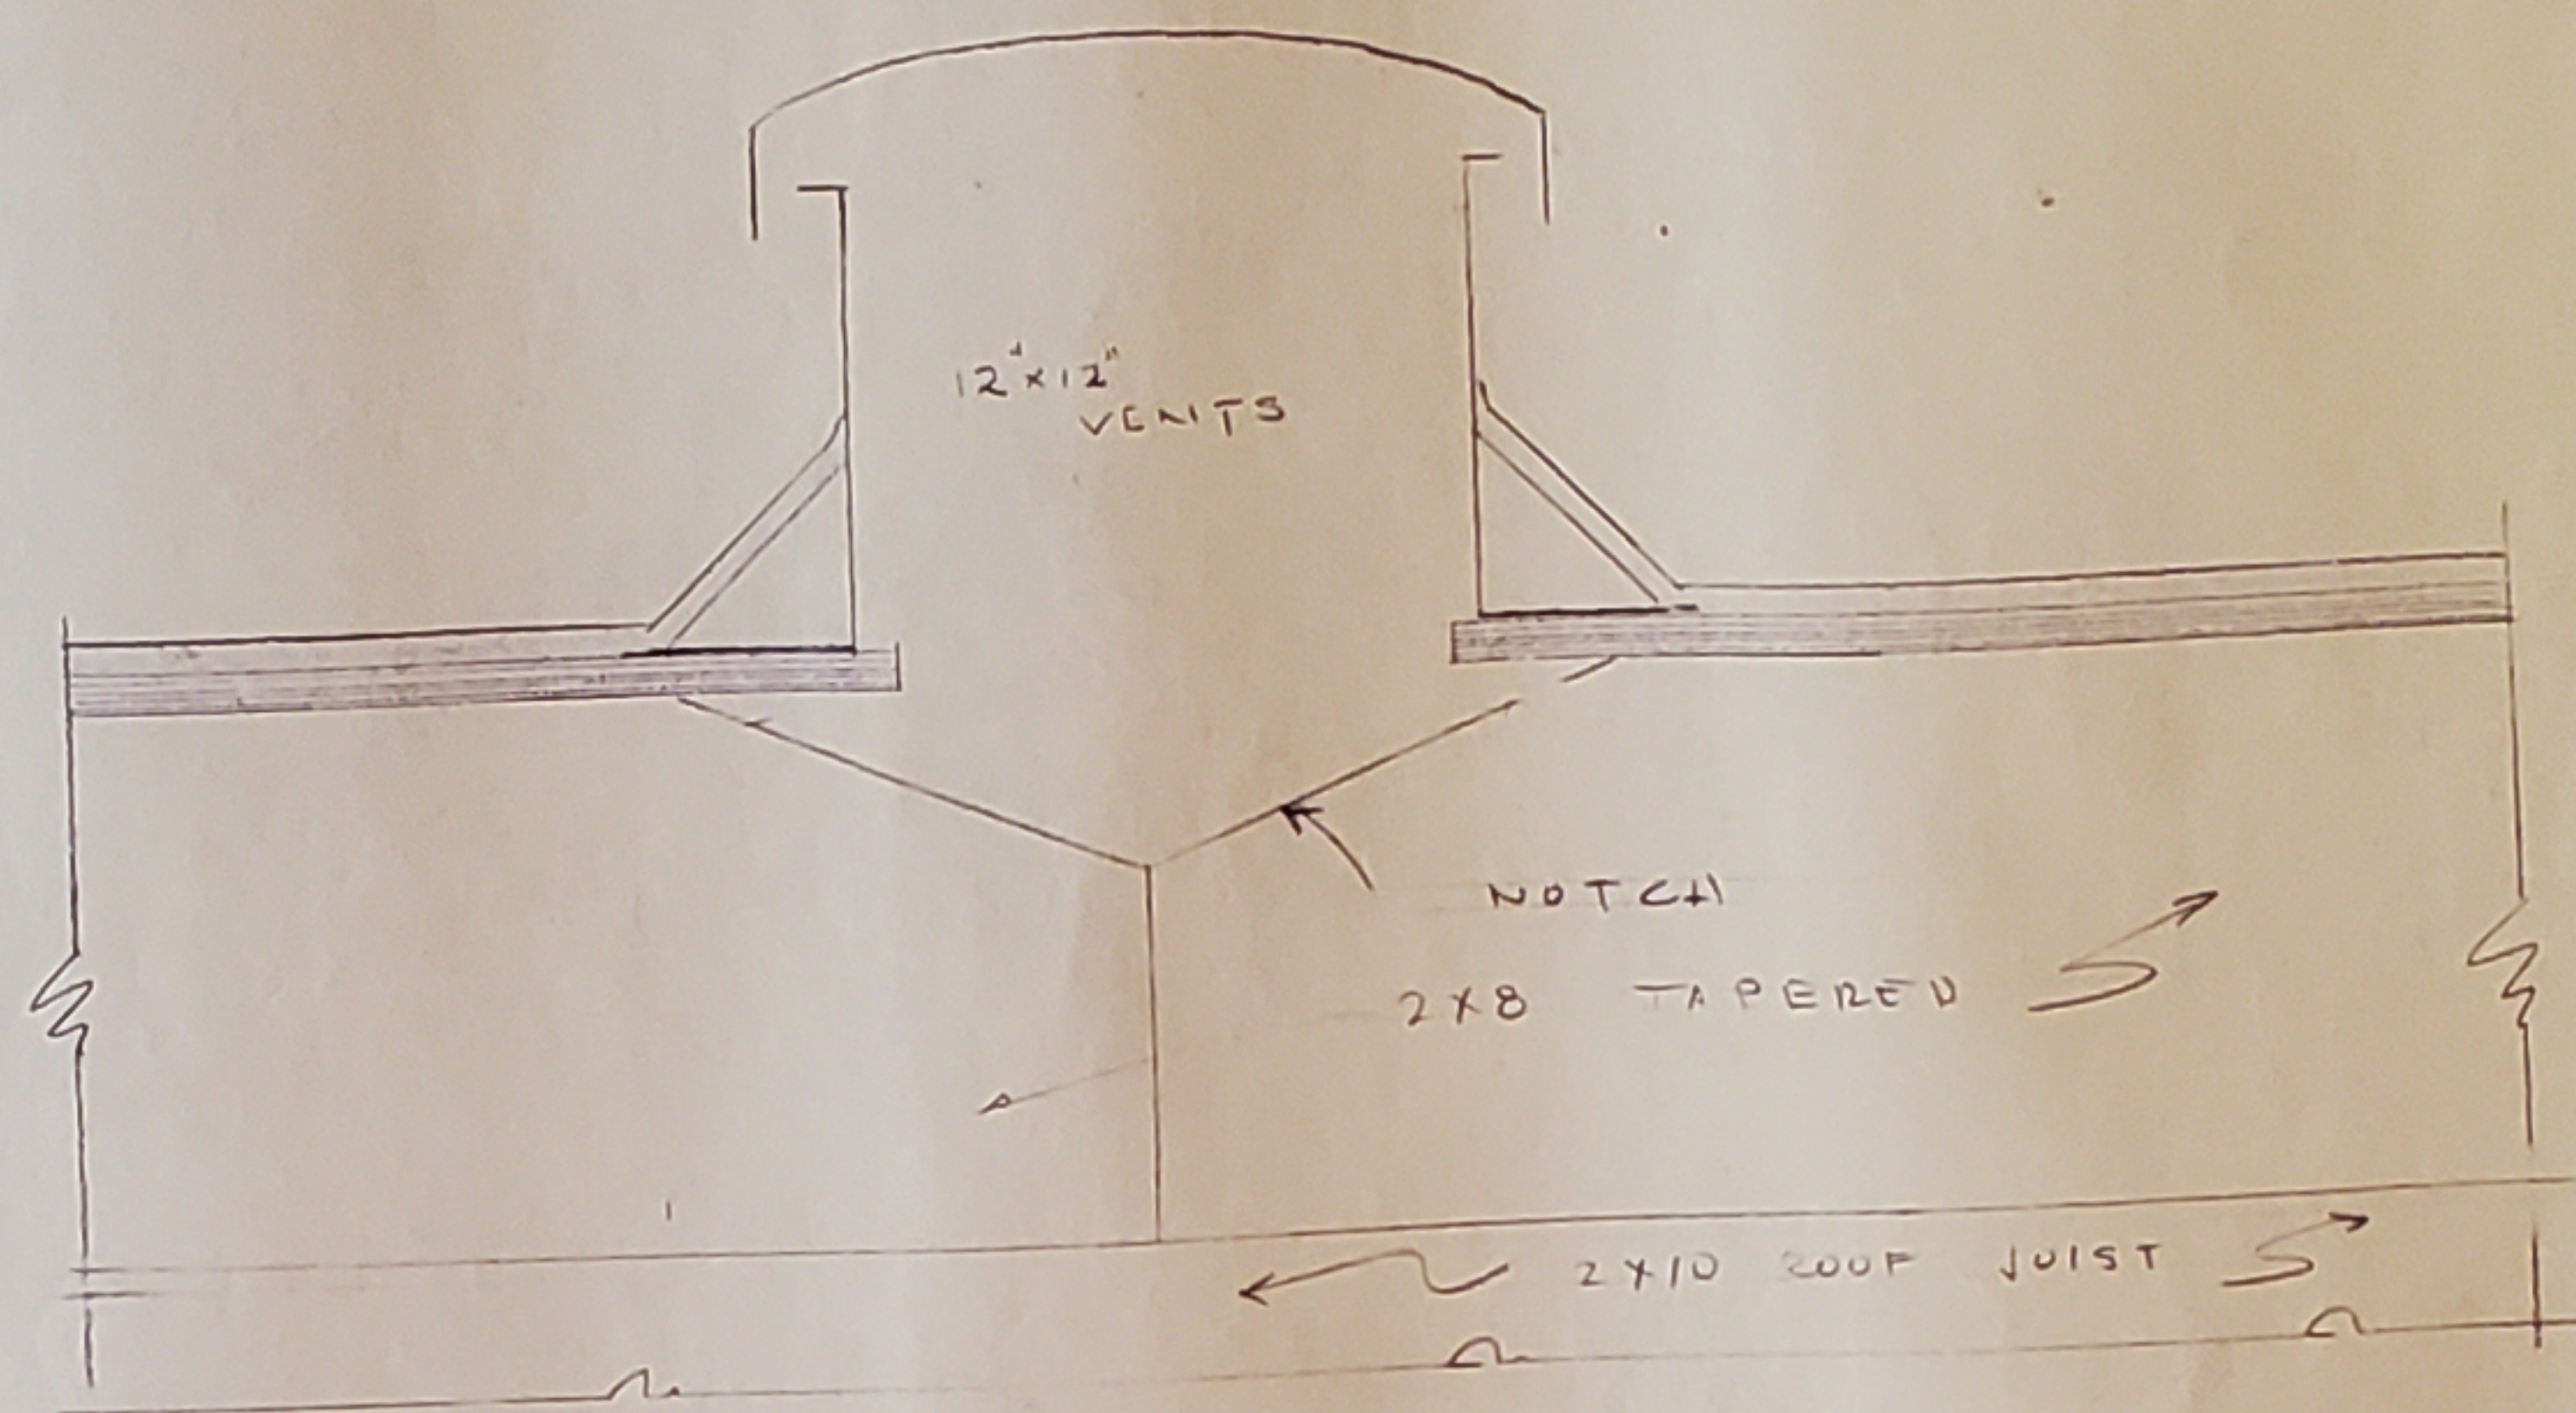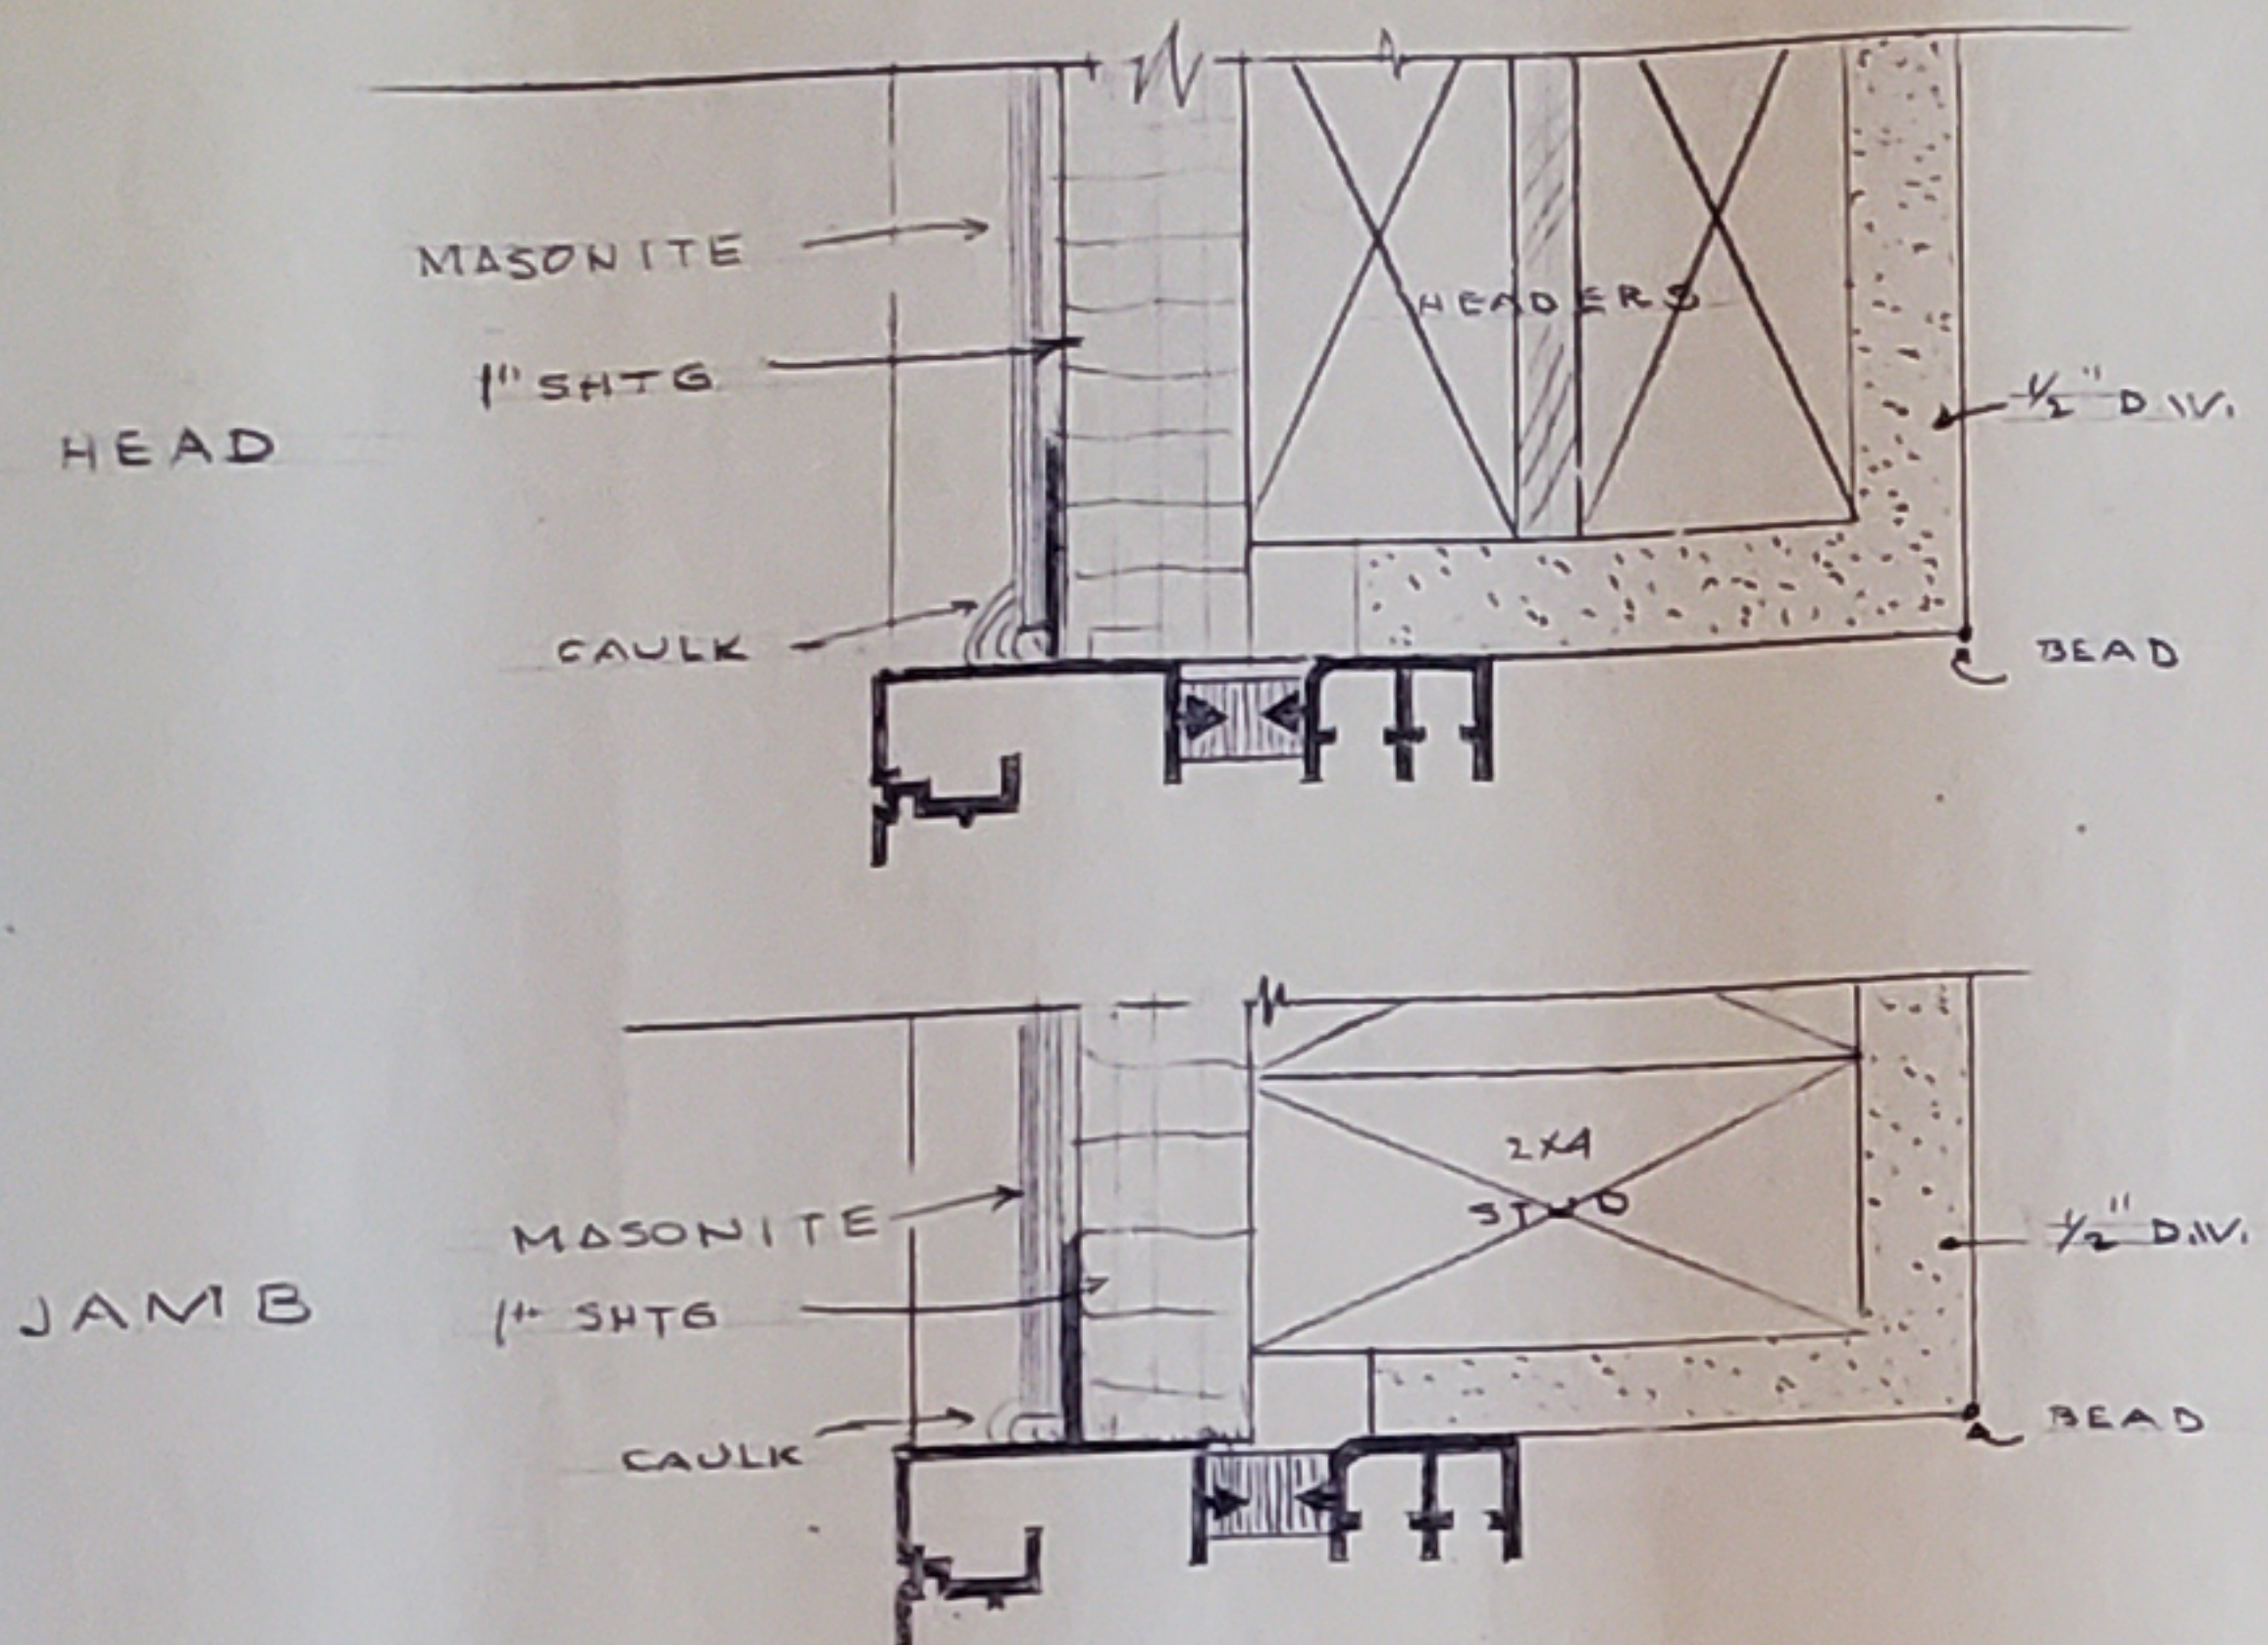


ROOF VENTS (4)
SCALE 3" = 1'-0"

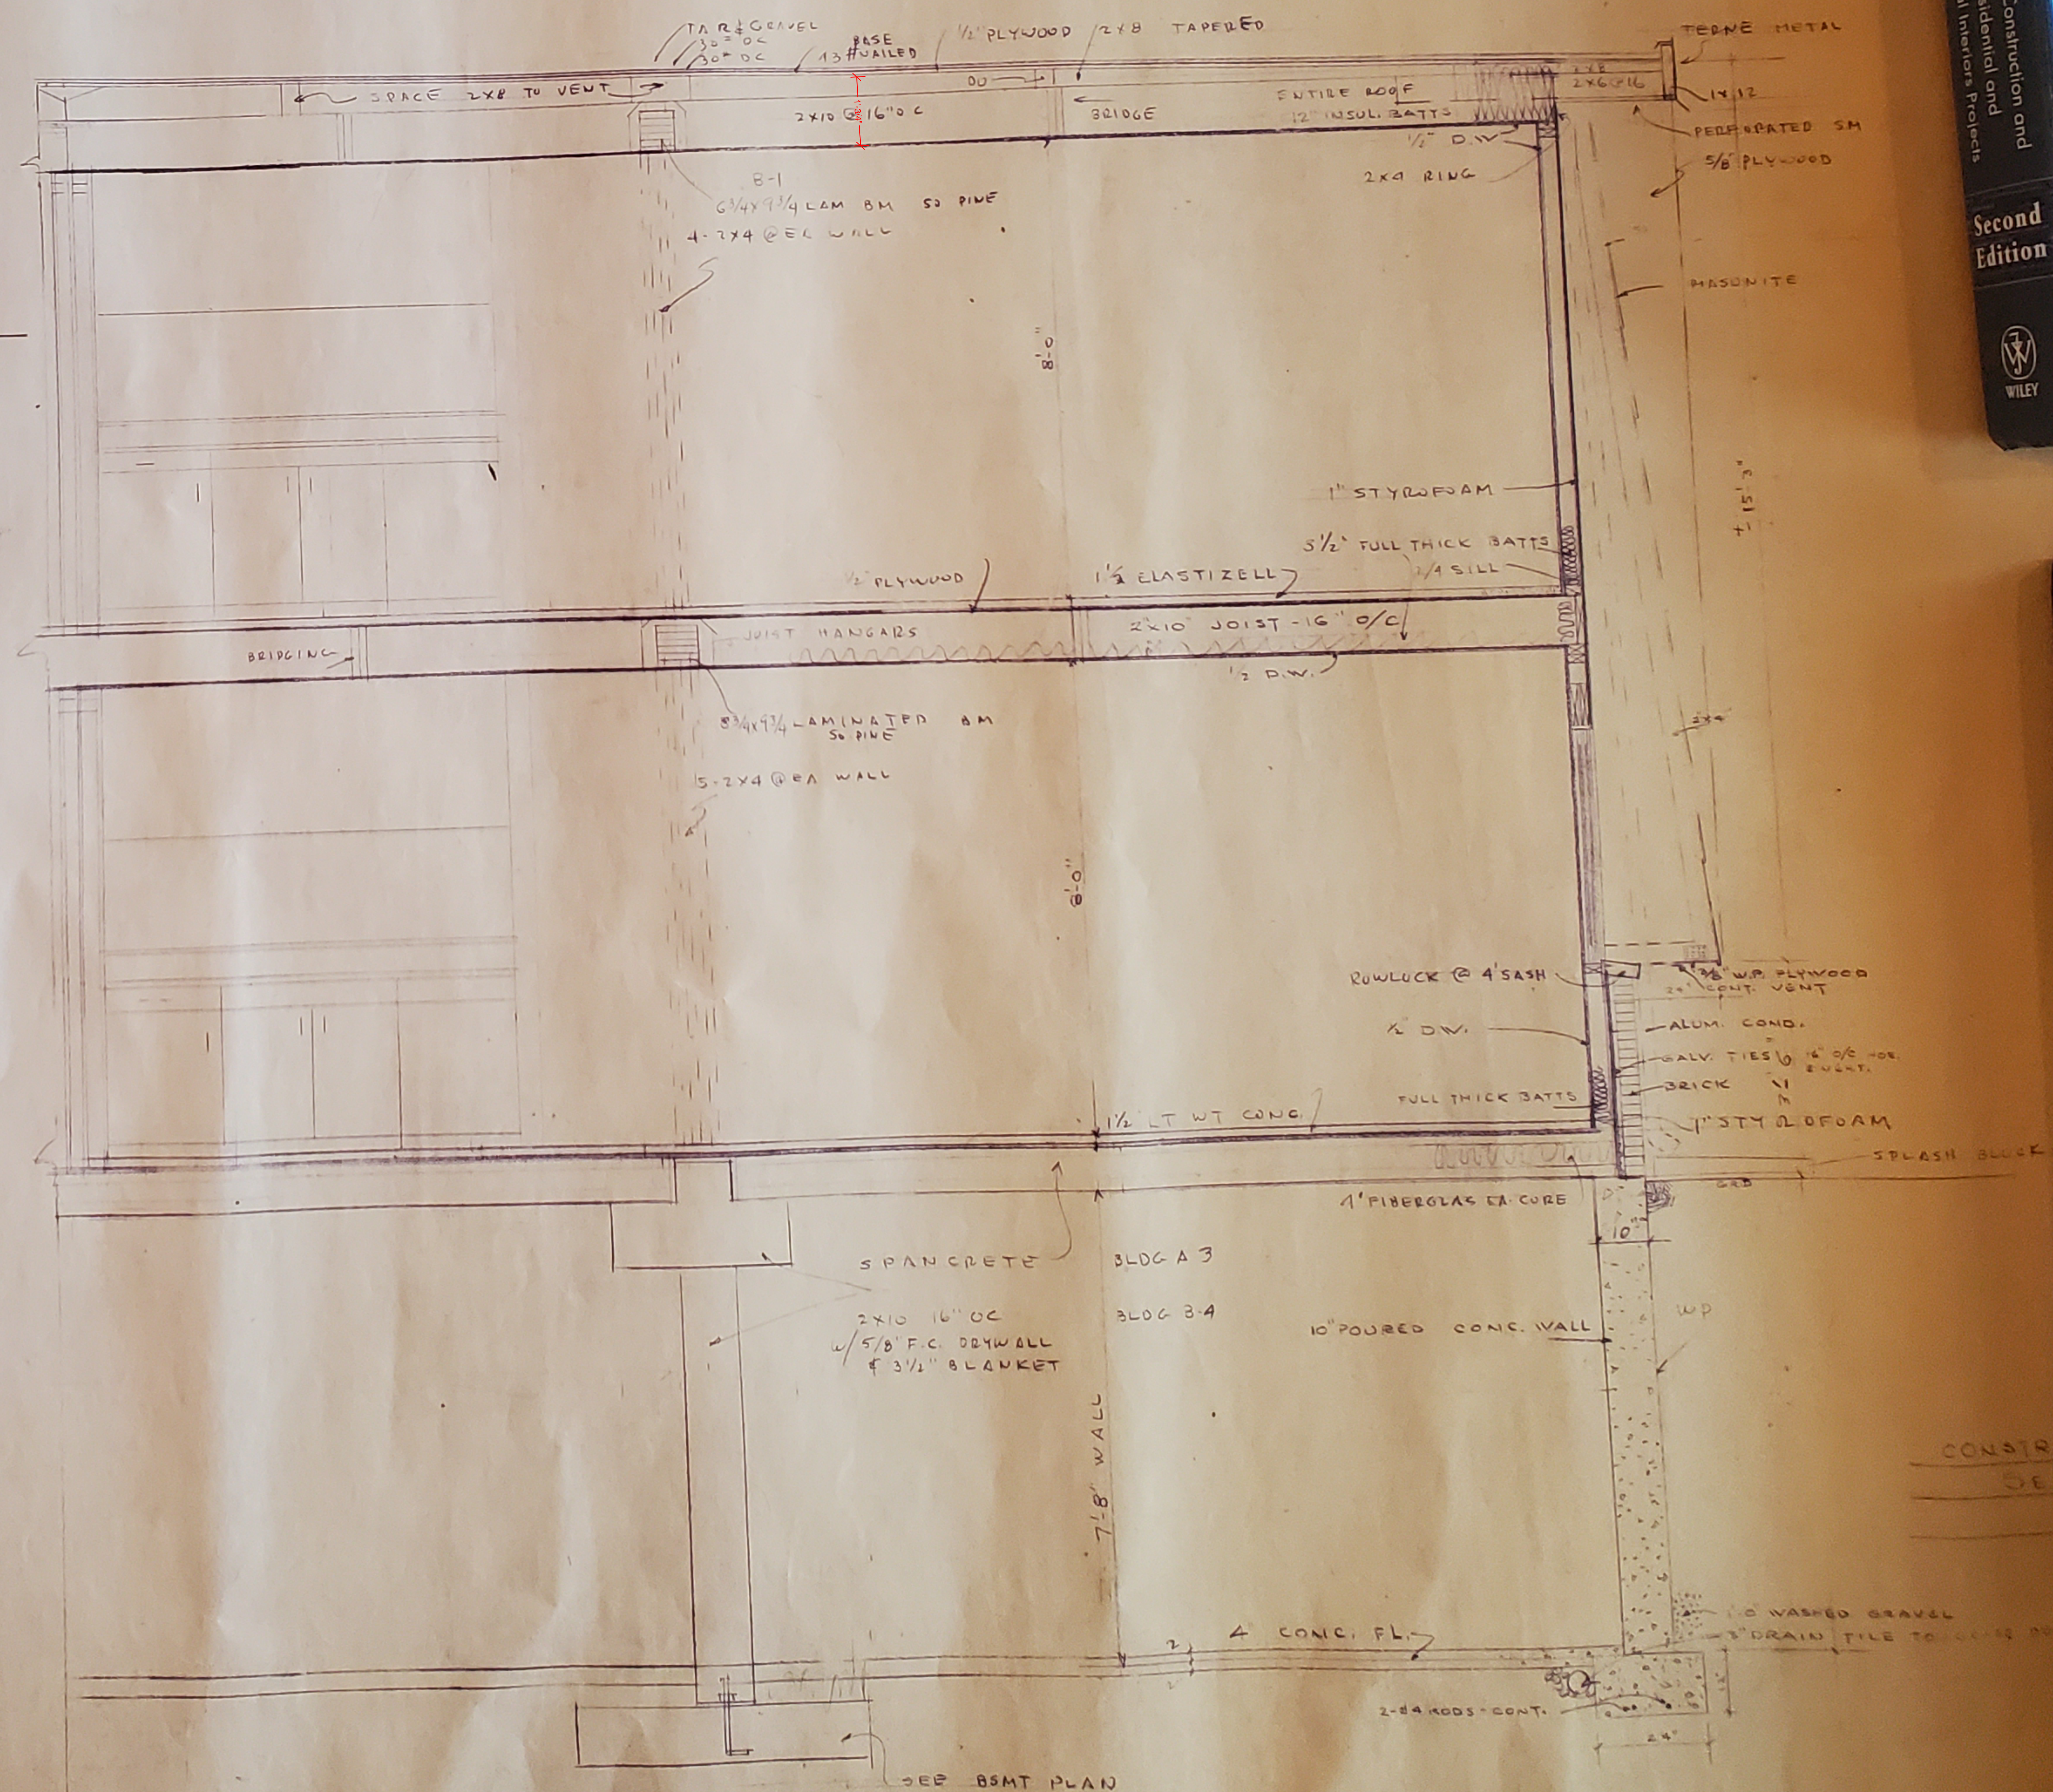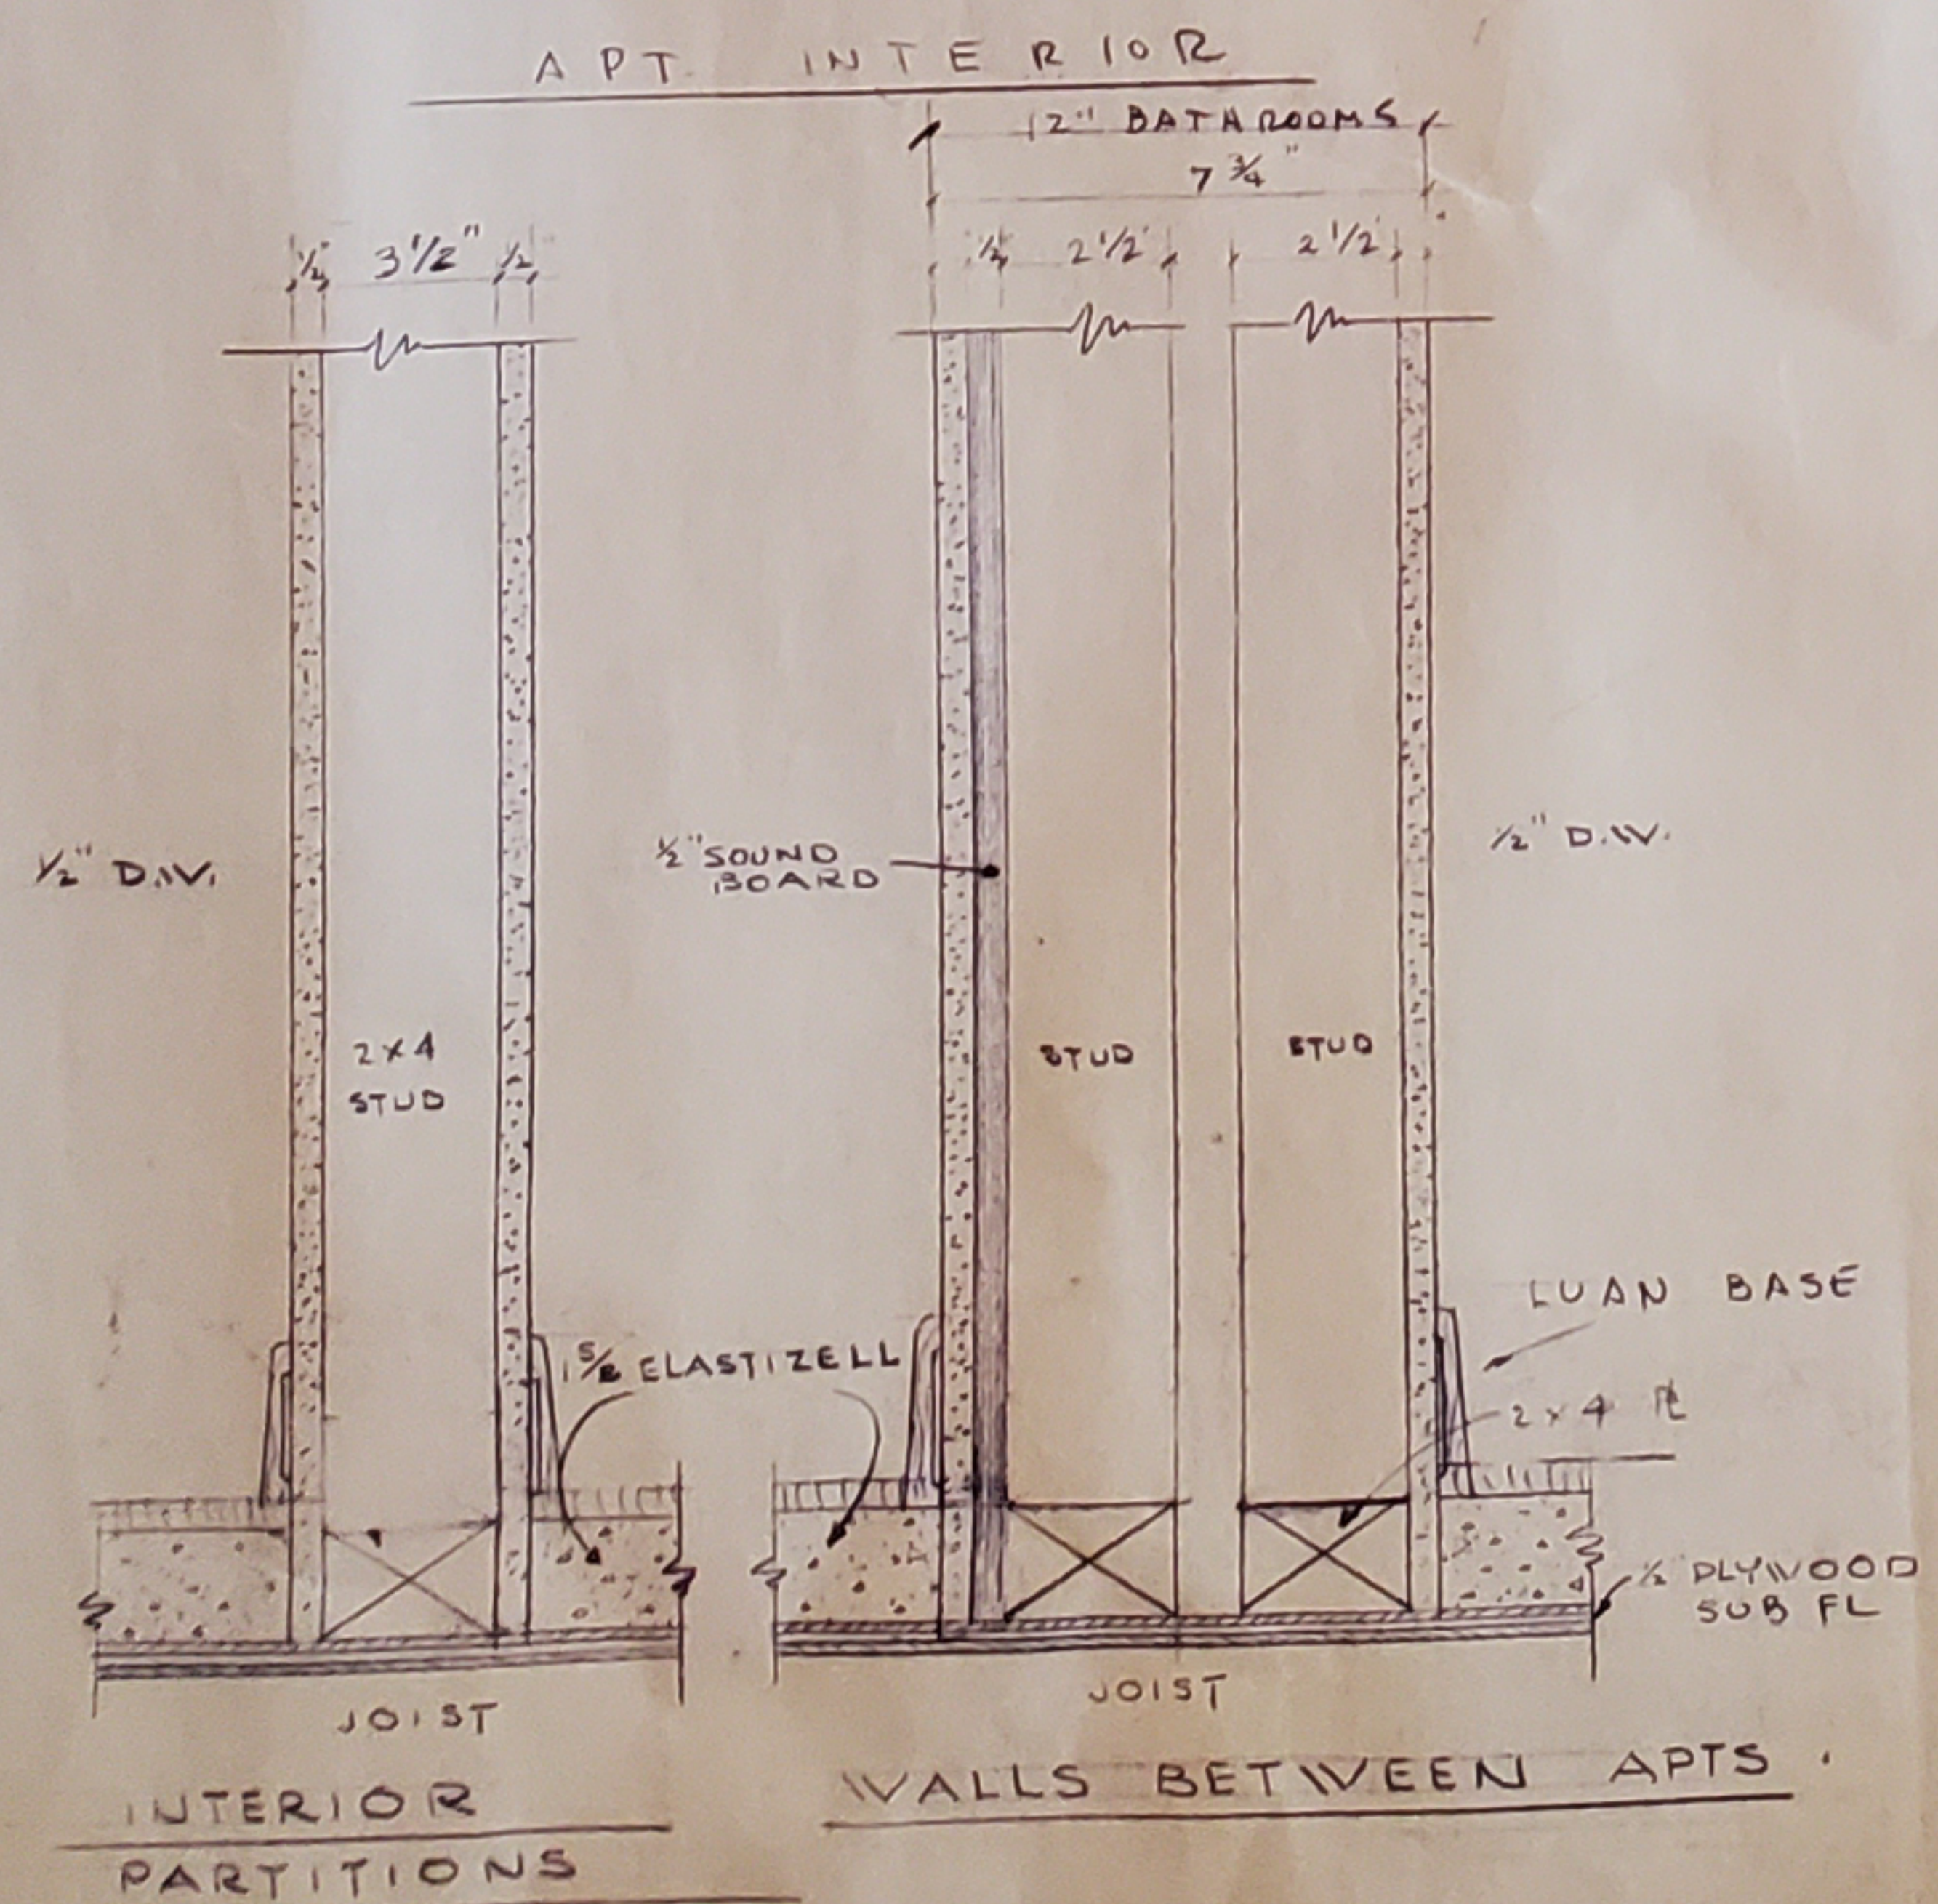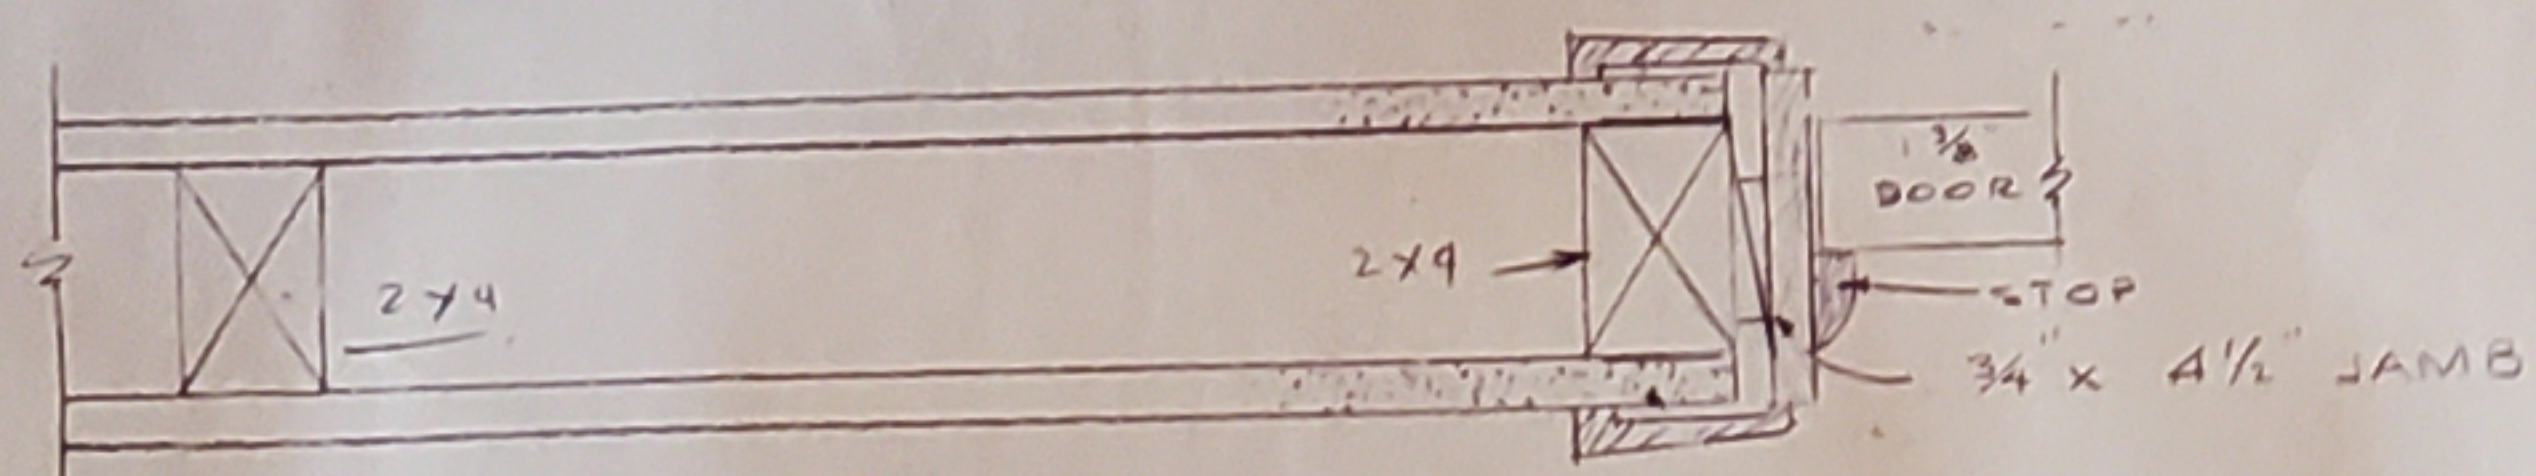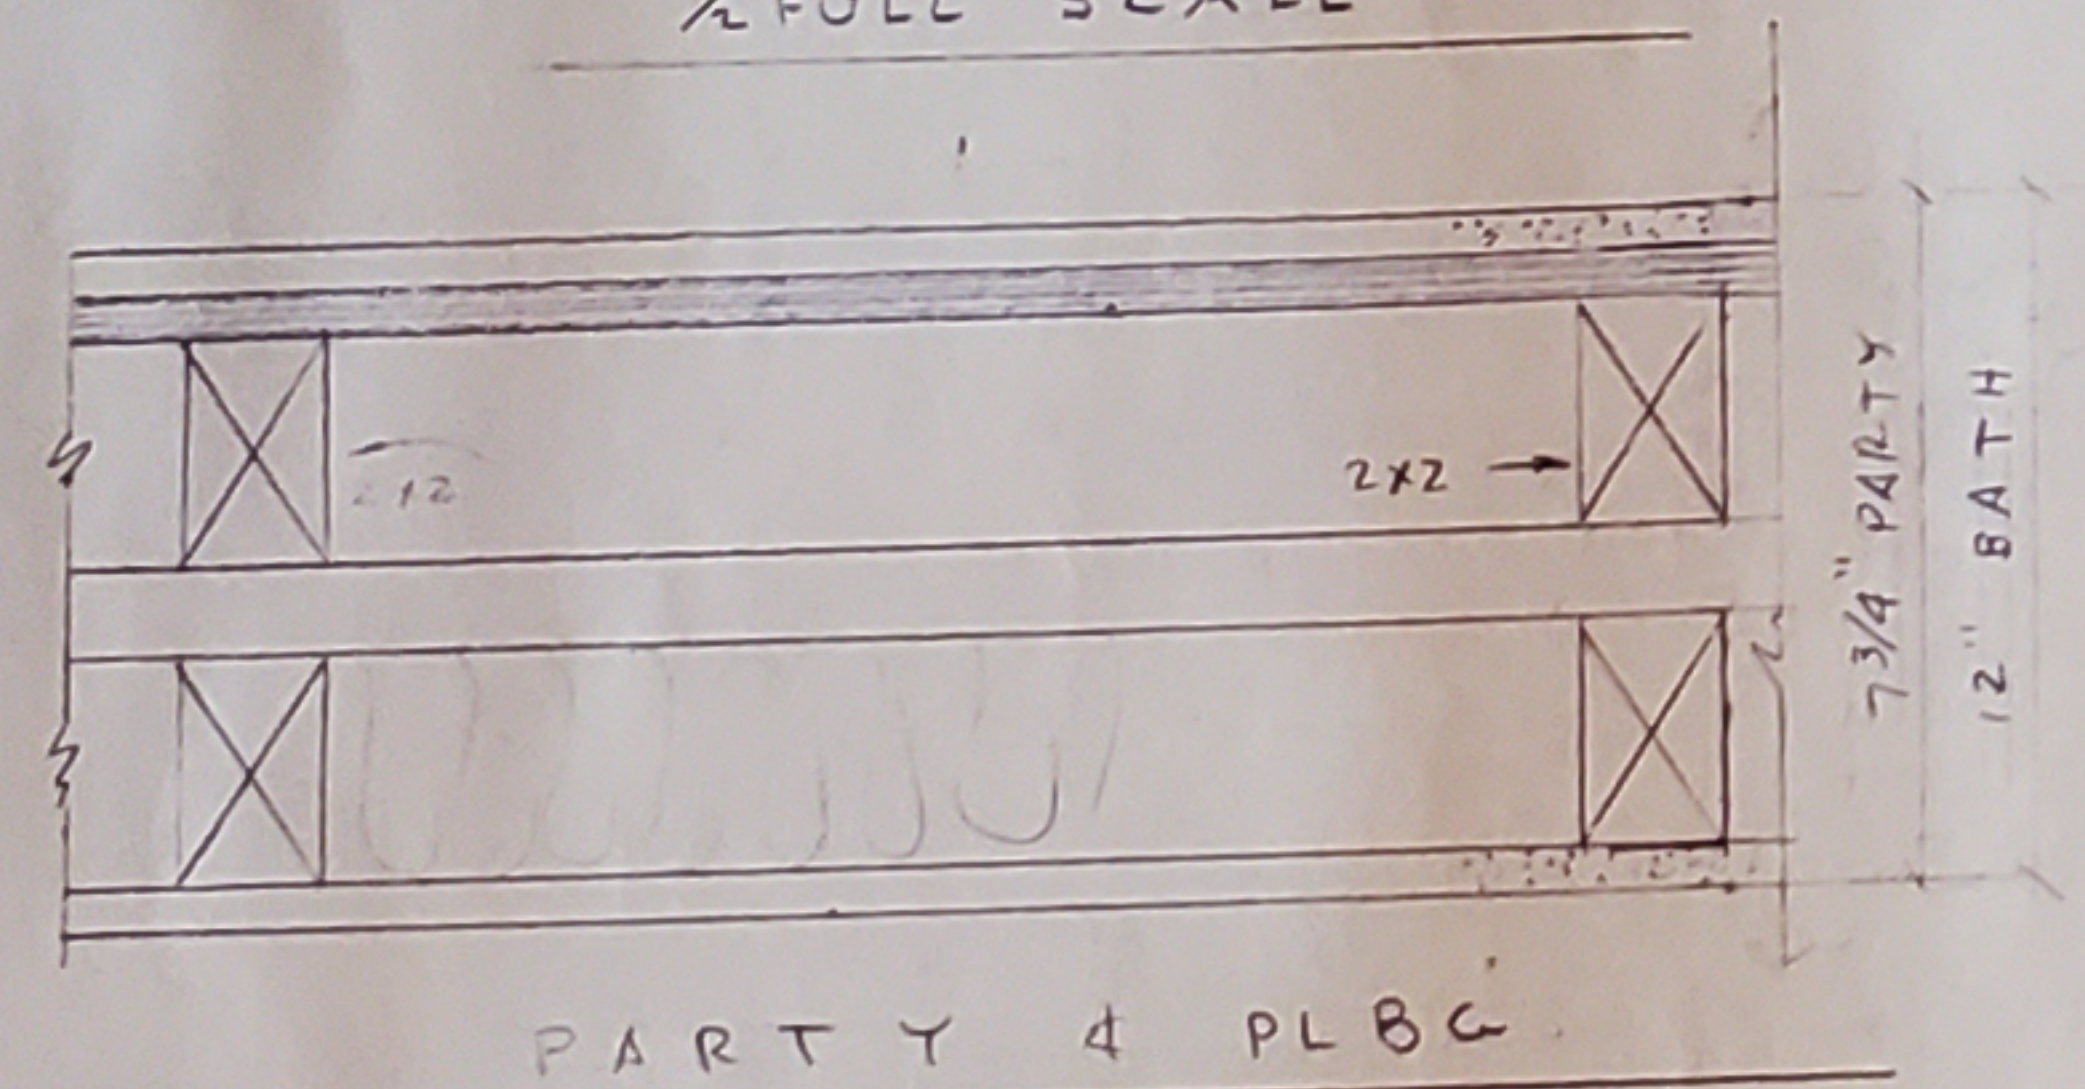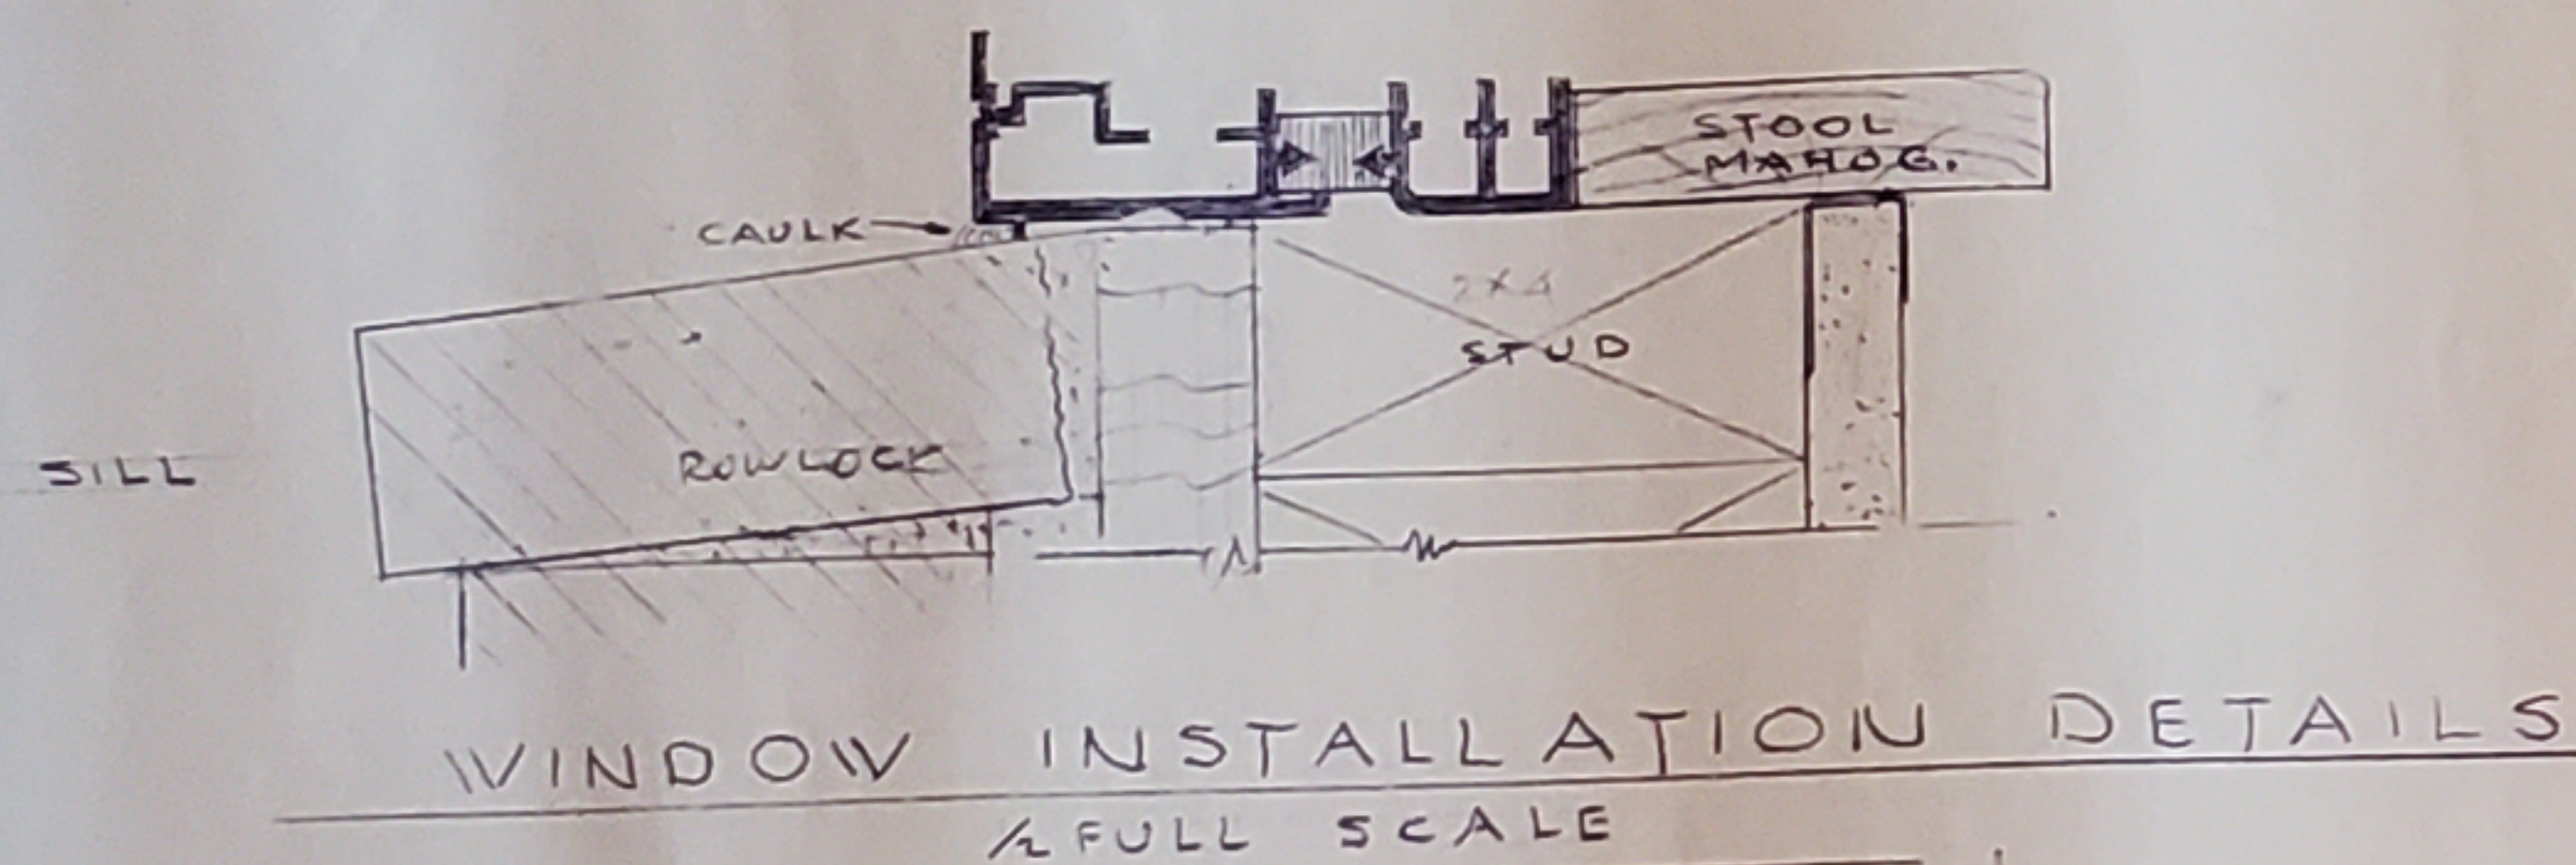


Specifying Interiors
A Guide to Construction and
FF&E for Residential and
Commercial Interiors Projects
Second Edition
WILEY

featuring steel

CONSTRUC
DECT
SCA

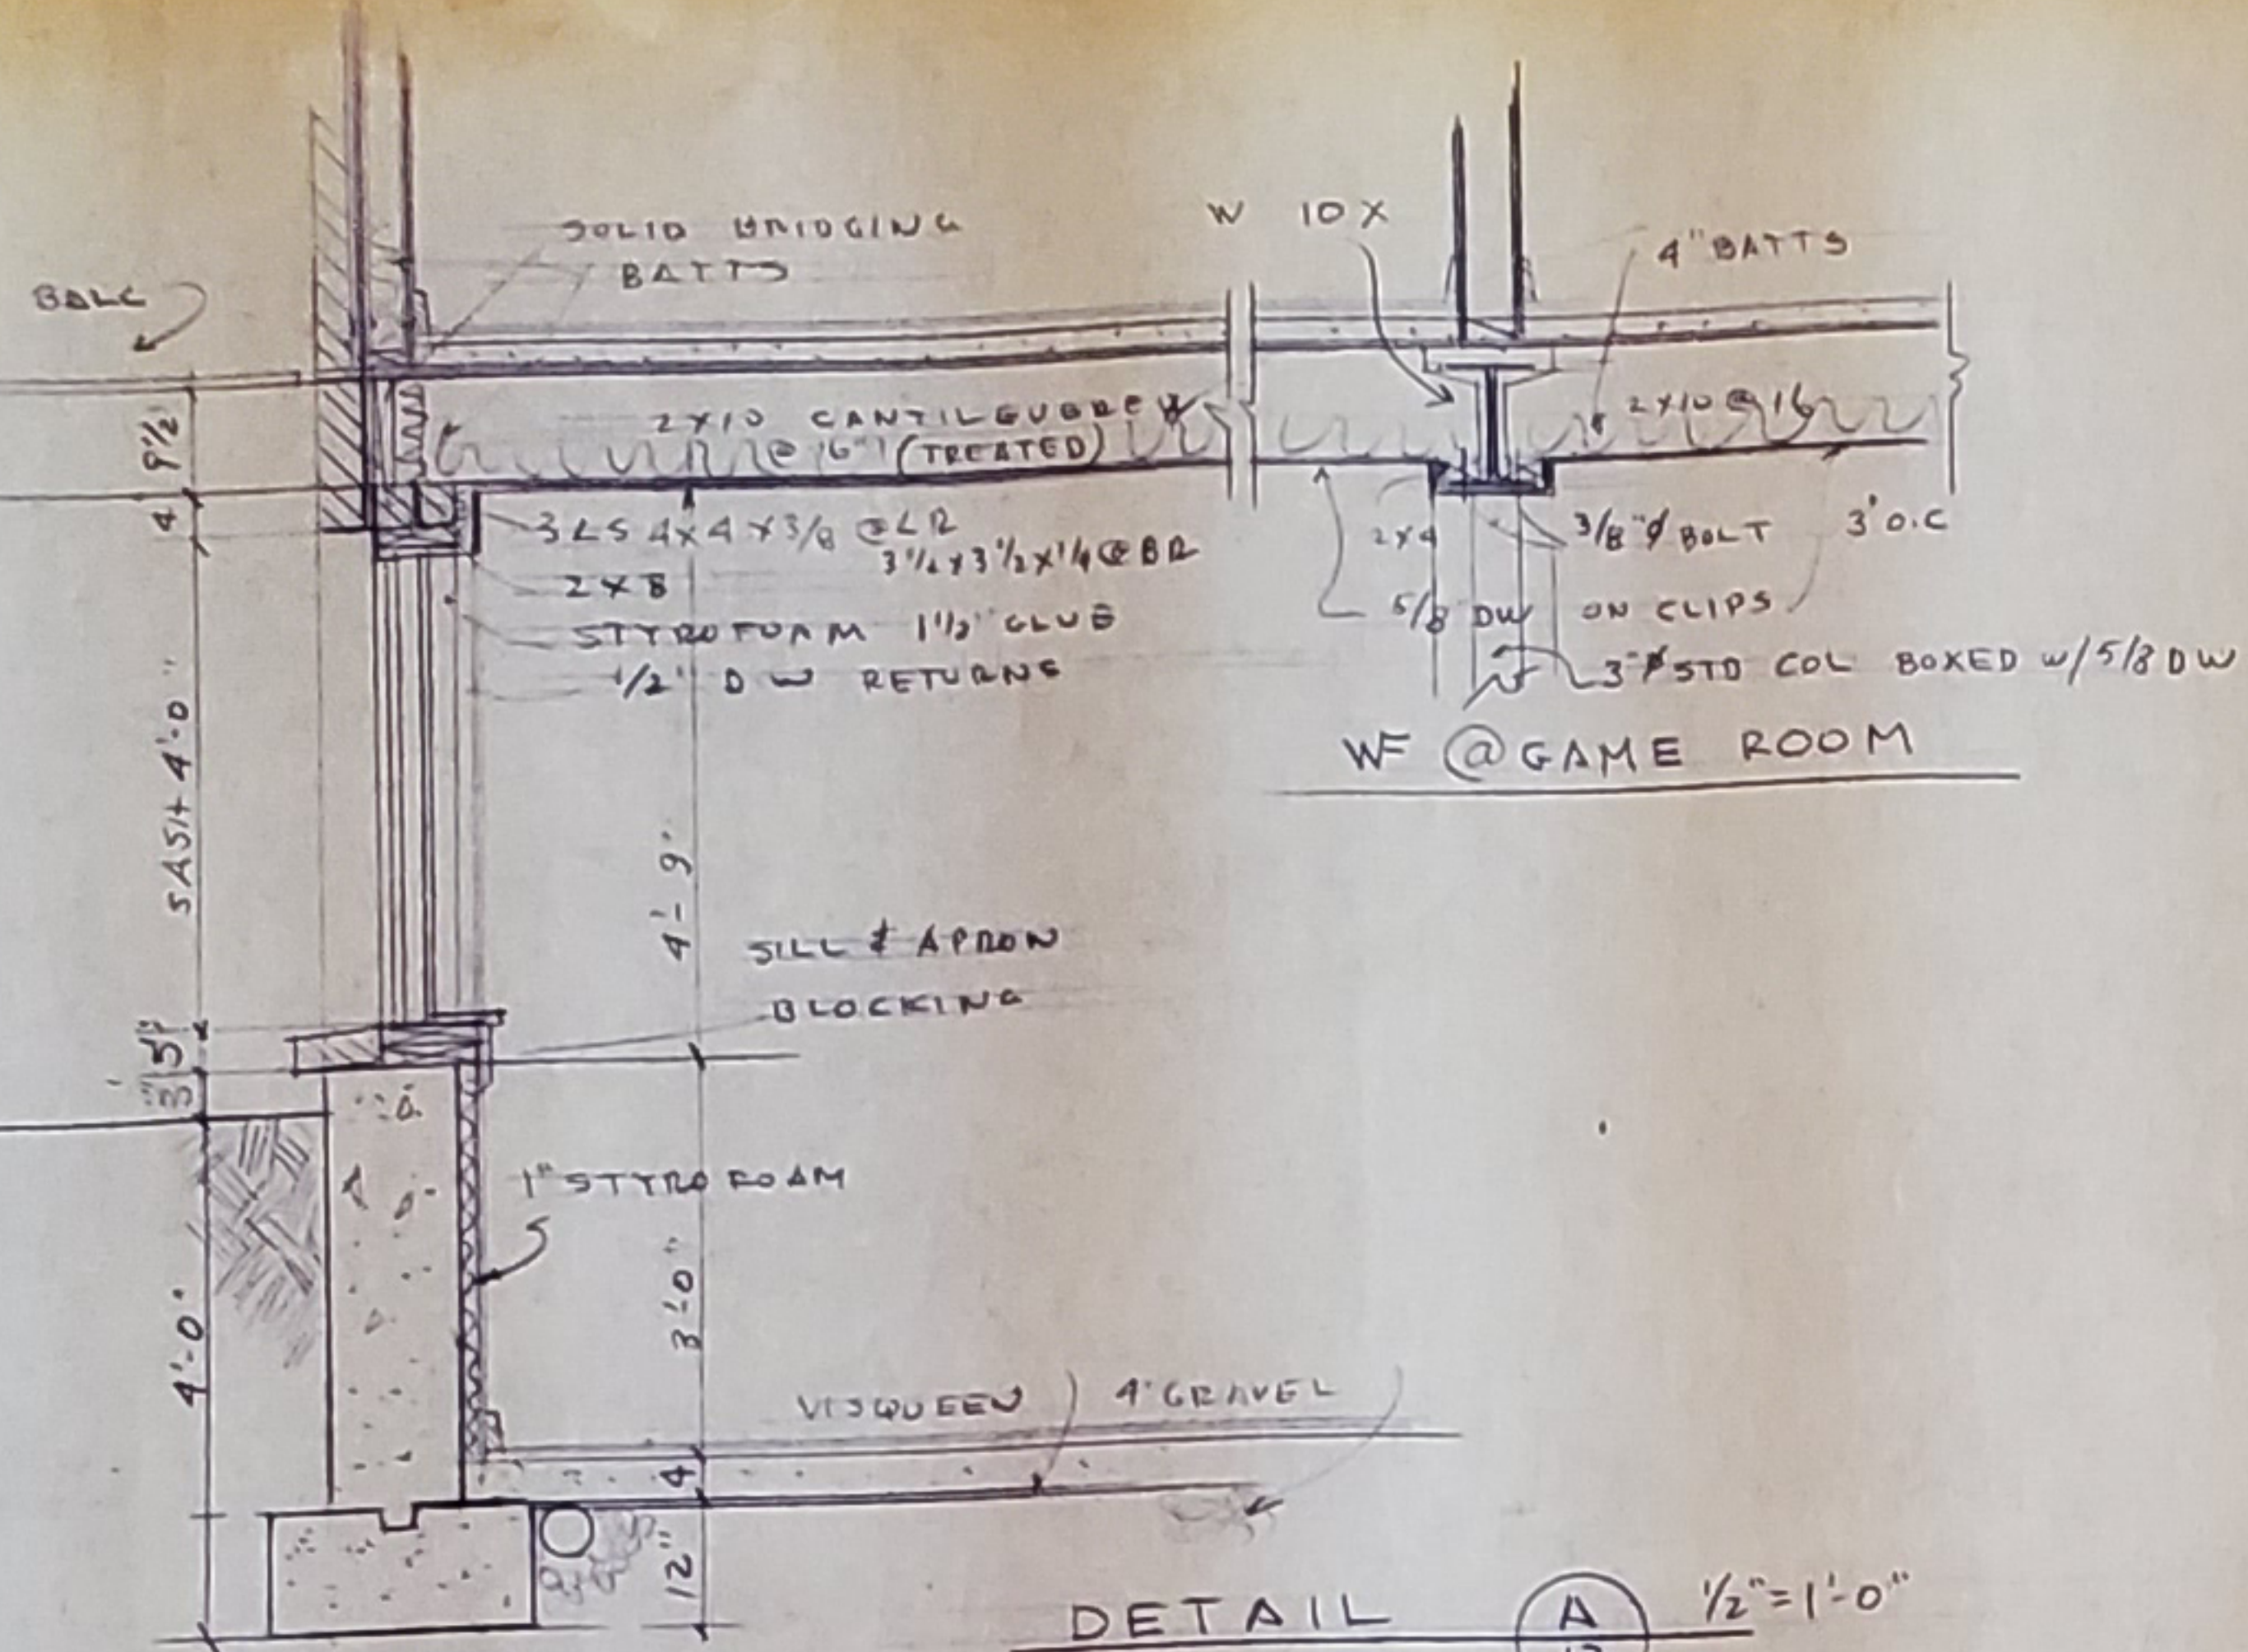


LITTLE
 FLOOR 62 PSF X 8' = 496
 BALC 110 PSF X 5' = 550
 WALL = 1' x 1' x 40 = 80
 1126 PLF
 M = 1126 X 8' / 8 = 9000
 S = 9000 / 12 / 12 = 62.5
 USE 3 L5 4 X 4 3/8 @ 4L
 3 L5 3 1/2 X 3 1/2 1/4 @ 8R

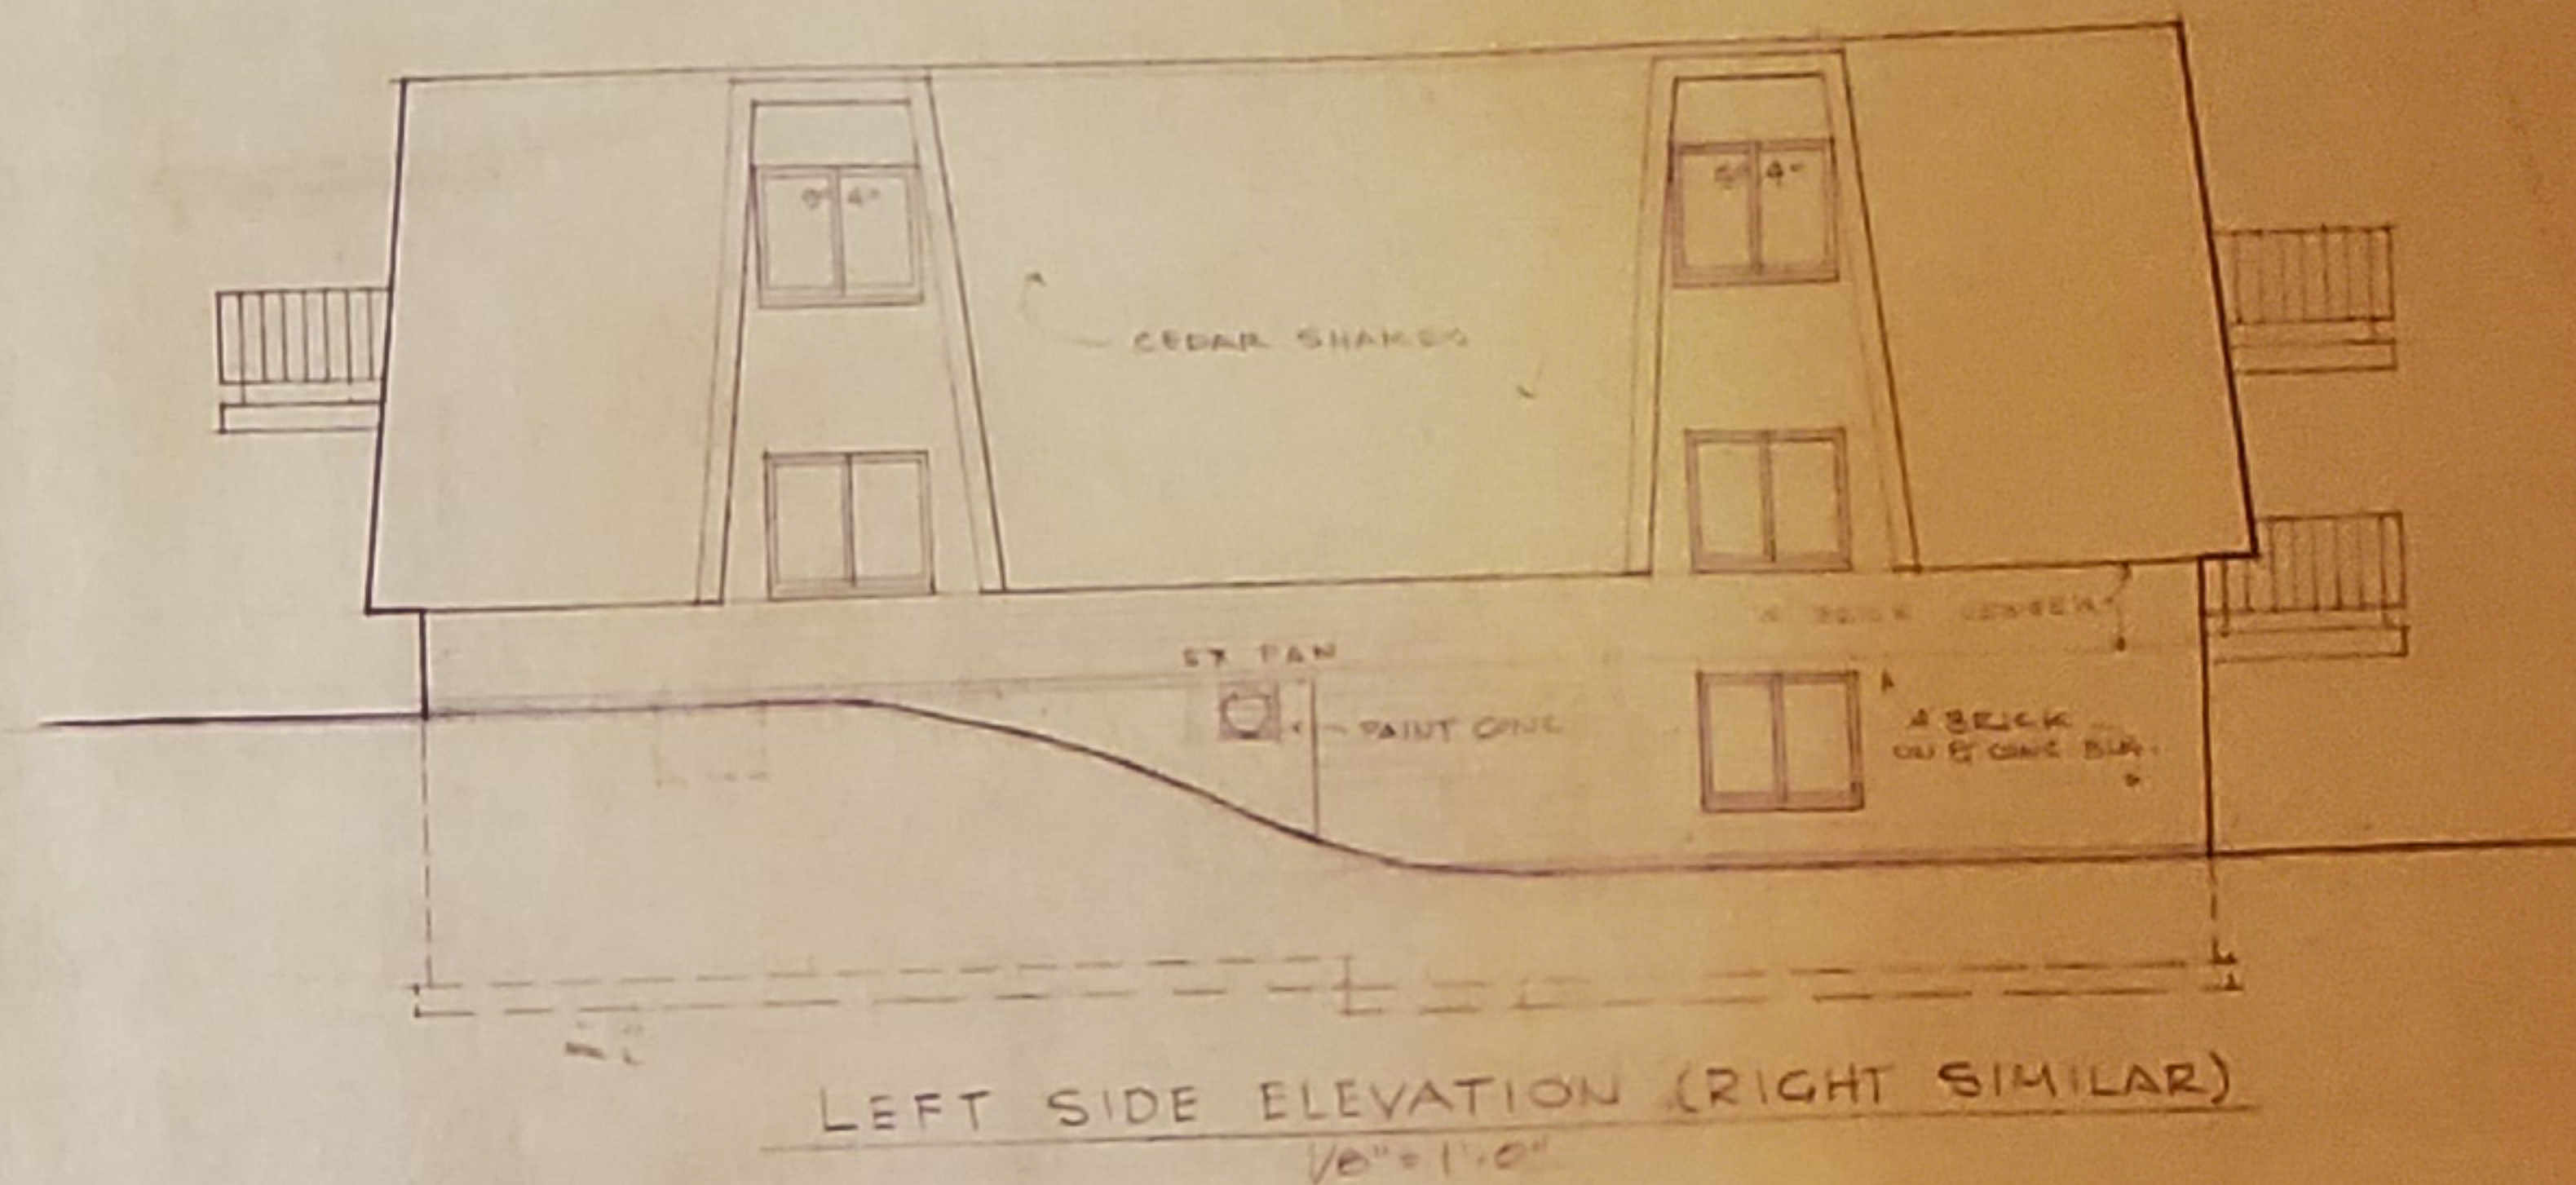


LEFT SIDE ELEVATION (RIGHT SIMILAR)
1/8" = 1'-0"



REAR ELEVATION A1+A2
1/8" = 1'-0"

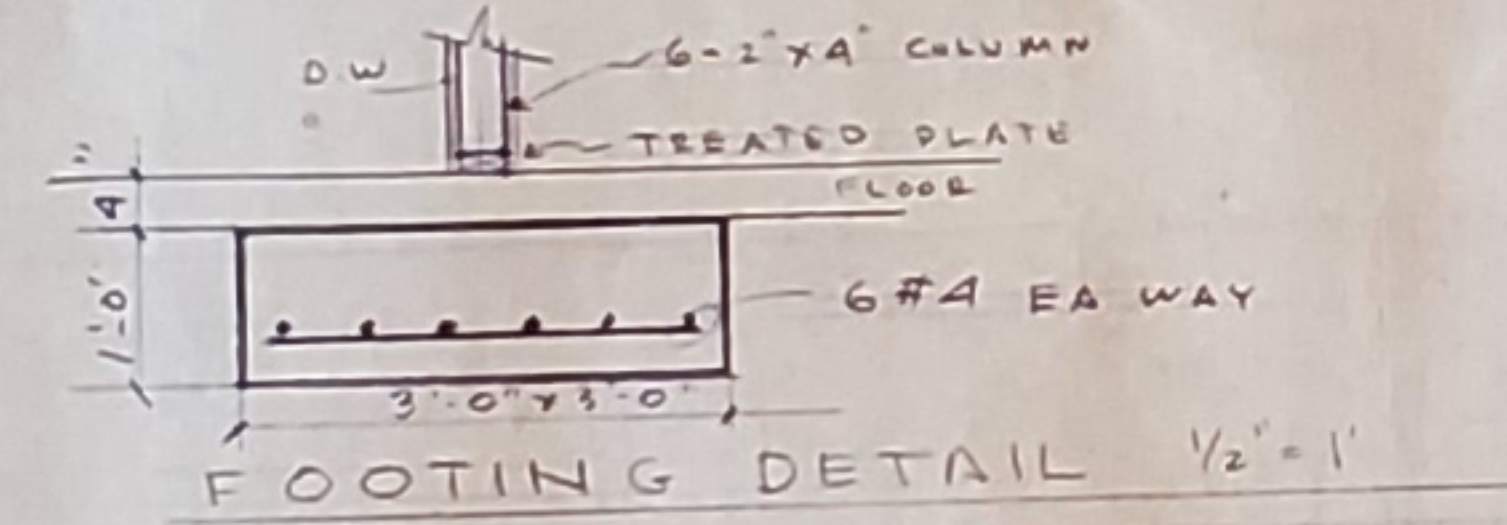

FOOTING DETAIL 1/2" = 1'

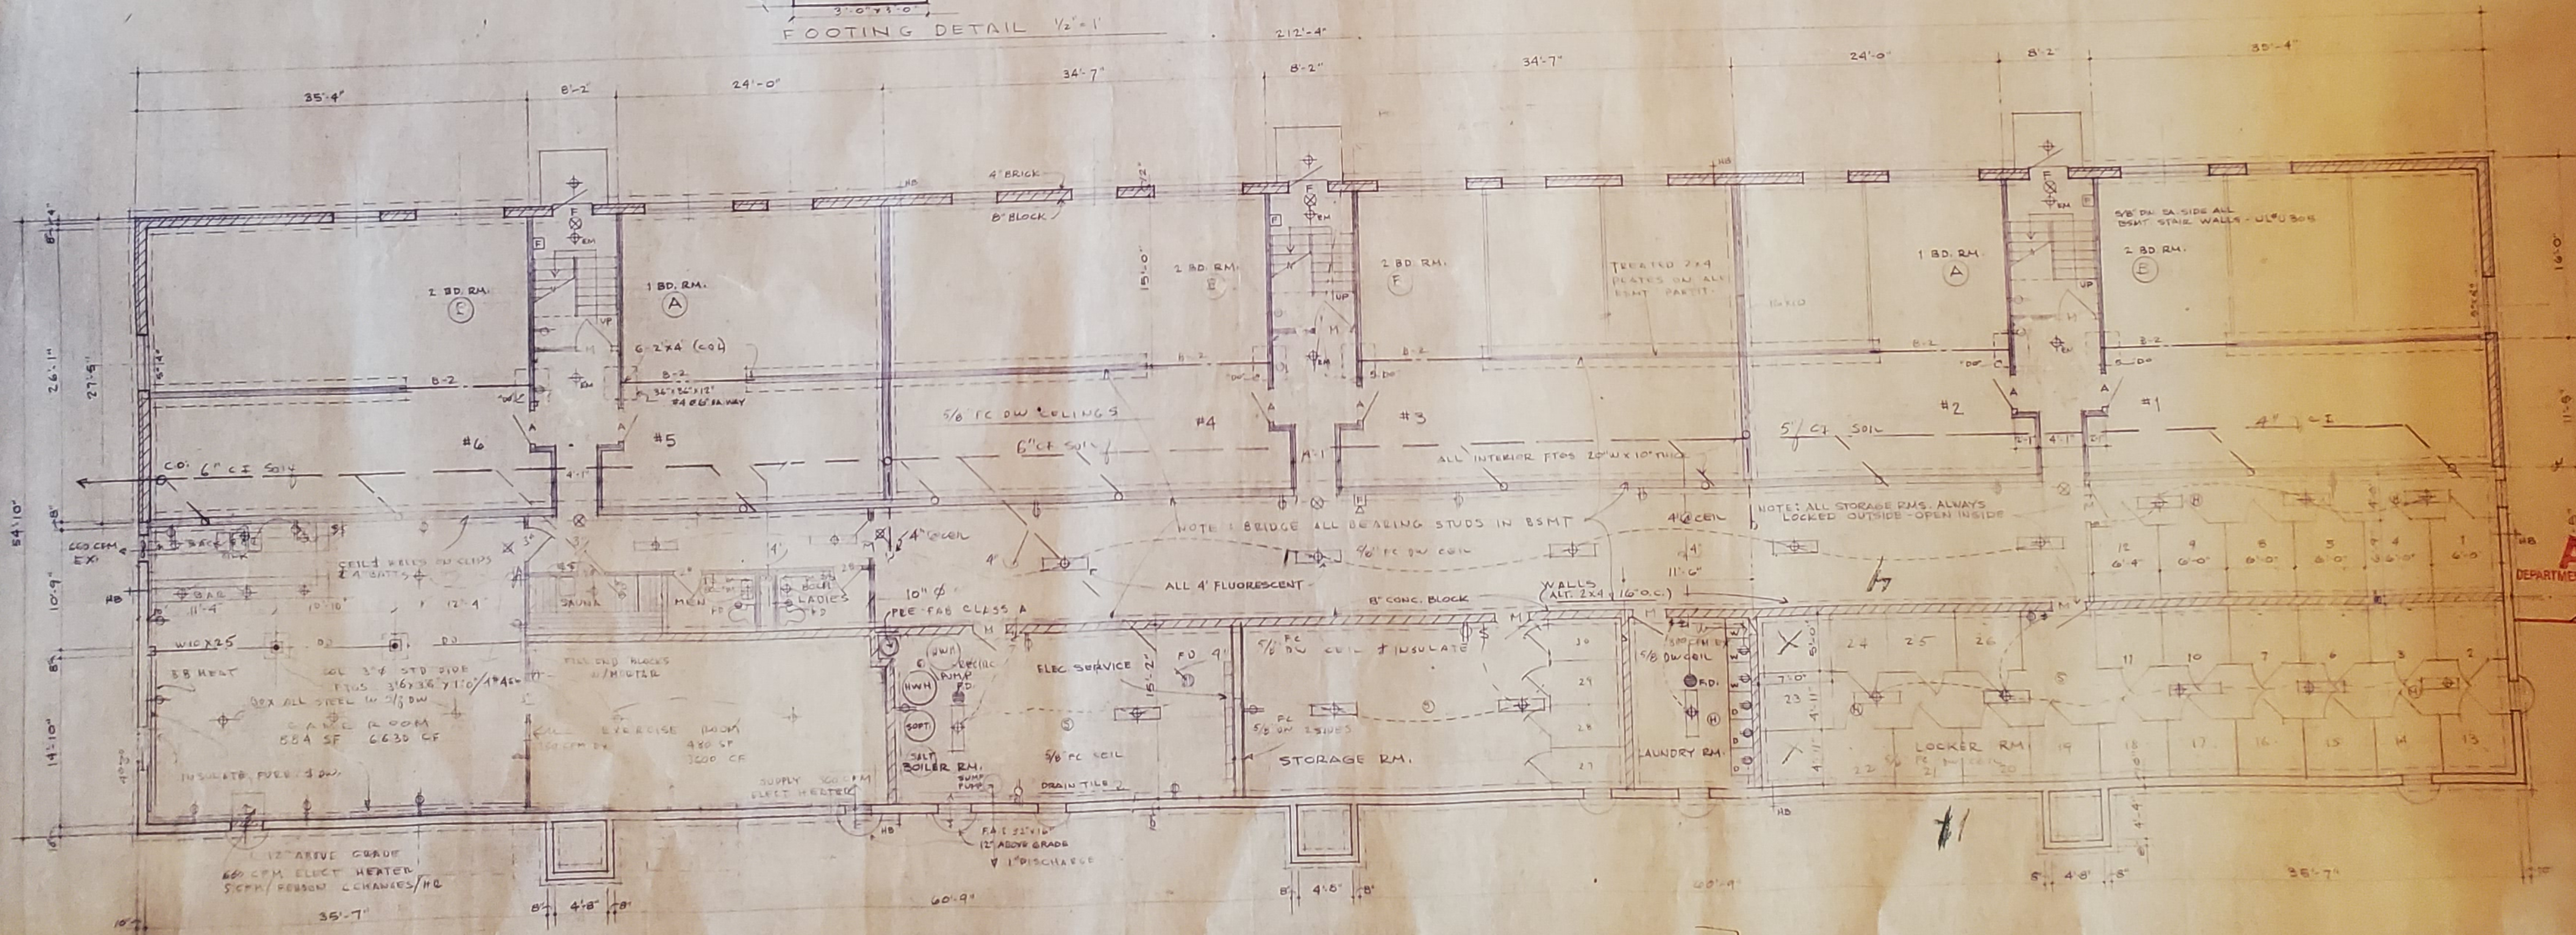

BASEMENT PLAN B-4 - 30 UNITS
1/8" = 1'-0"

APPRO
 DEPARTMENT OF INDUSTRY LABOR
 DIVISION OF SAFETY AND
 HEALTH


NO.	DATE	BY	REVISIONS

ROBERT STAUBER & ASSOCIATES
 ARCHITECTS-ENGINEERS
 MADISON, WISCONSIN
 53713

SHEET
 OF
 TYPICAL APTS. & CABINETS
 DRAWN BY
 APPROVED BY
 DATE
 7/19/80


REVISED 10-1-80

TYPICAL APARTMENTS
 1/4" = 1'-0"

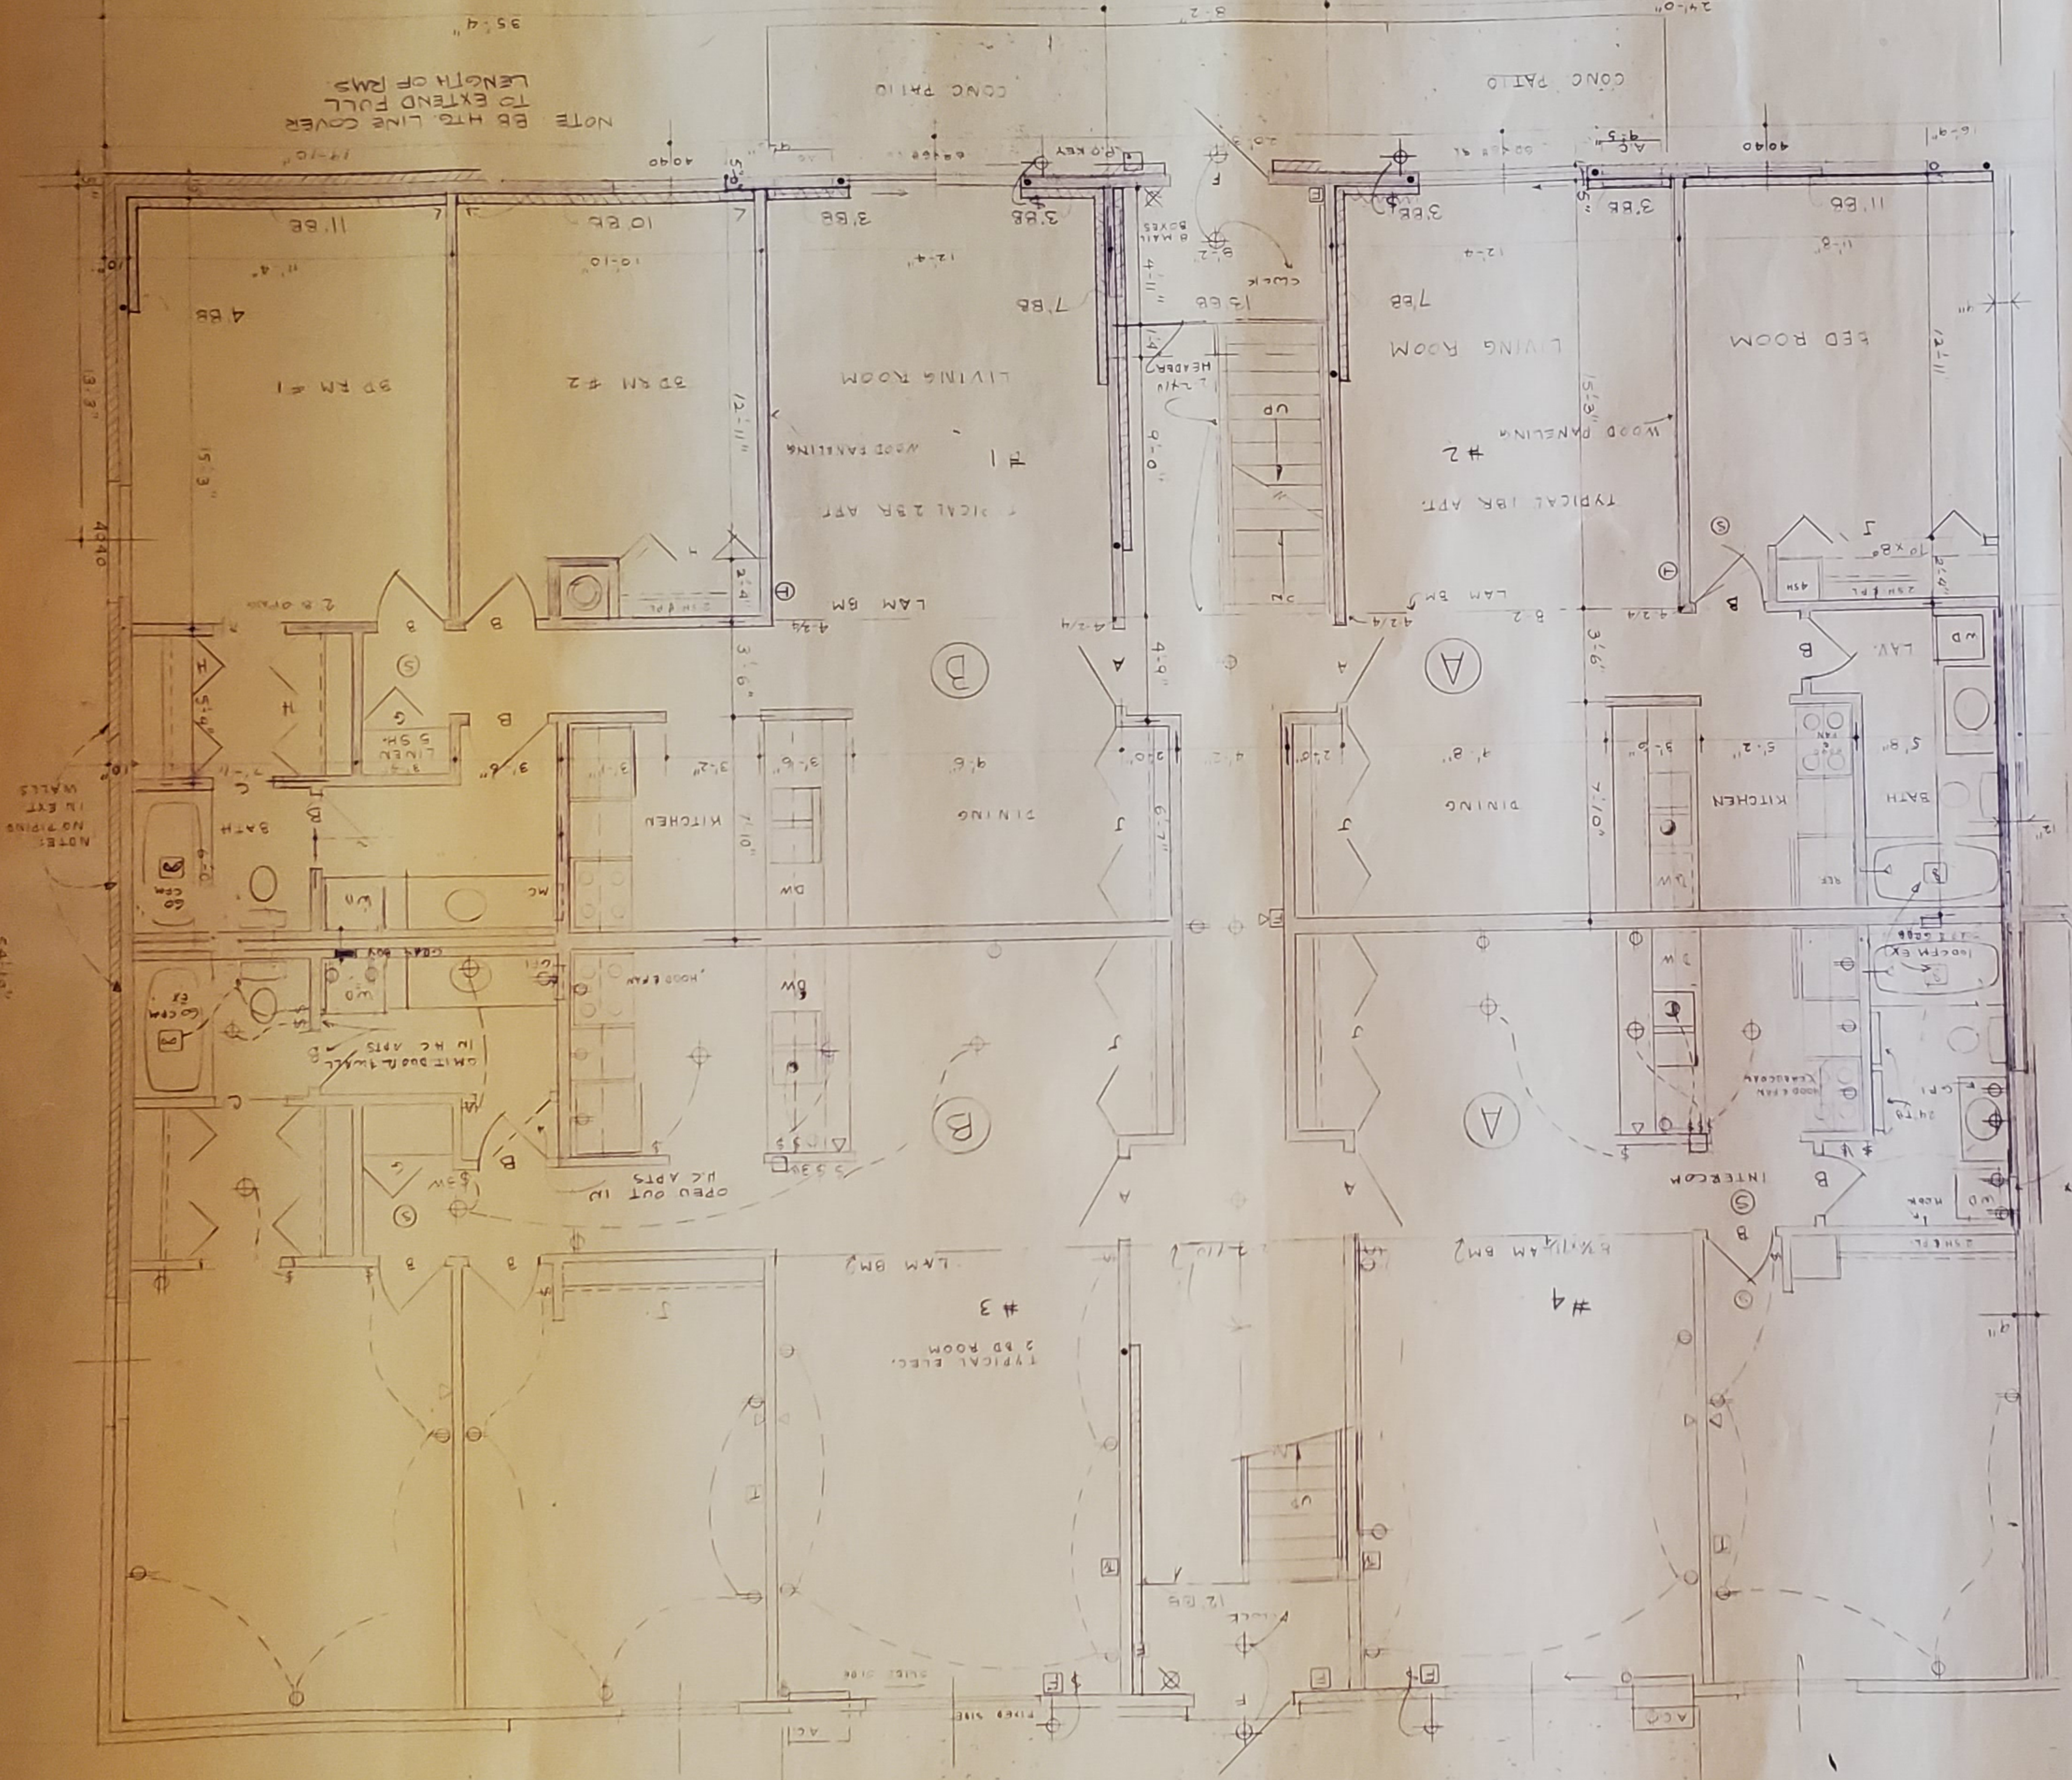


NOTE
 BB HTG. LINE COVER
 TO EXTEND FULL
 LENGTH OF RMB

TYP VANITY DETAIL
 1/2" = 1'-0"

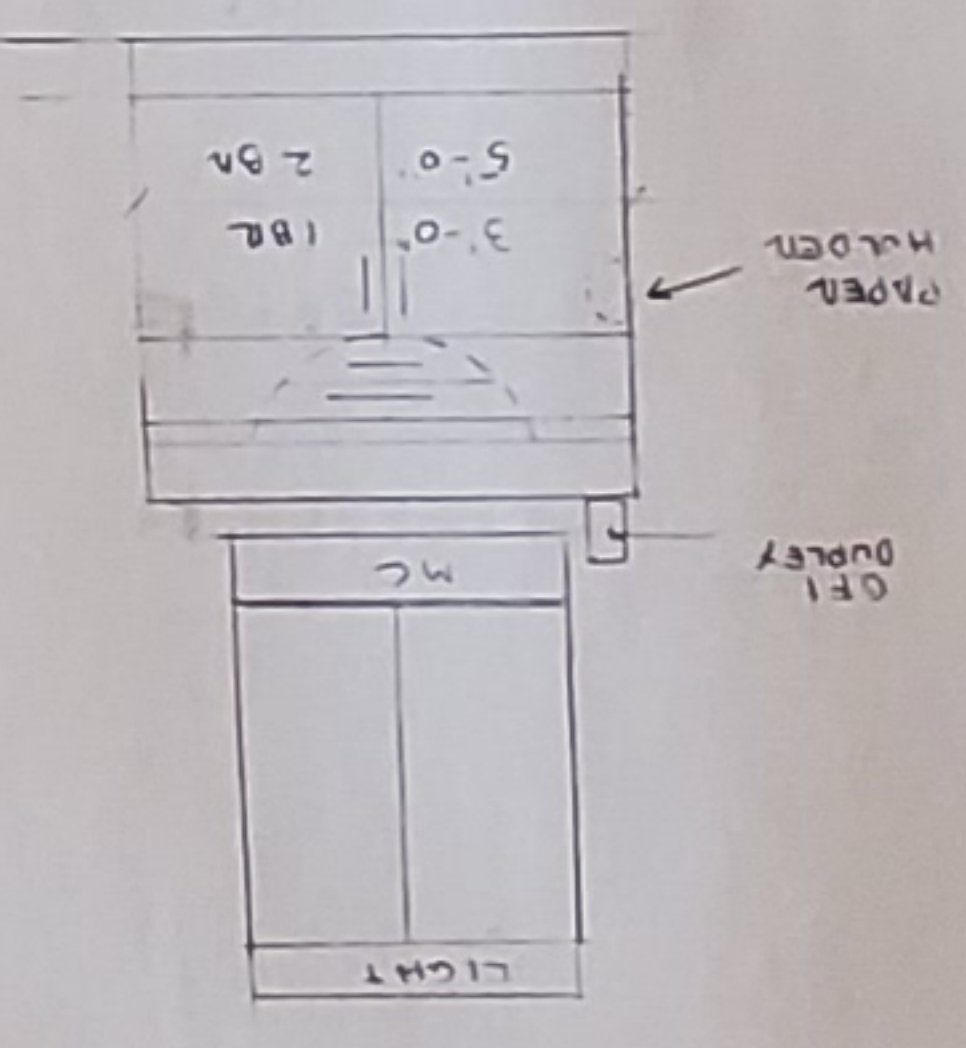

TYP. KITCHEN CABINET DETAILS - ALL APTS
 1/2" = 1'-0"

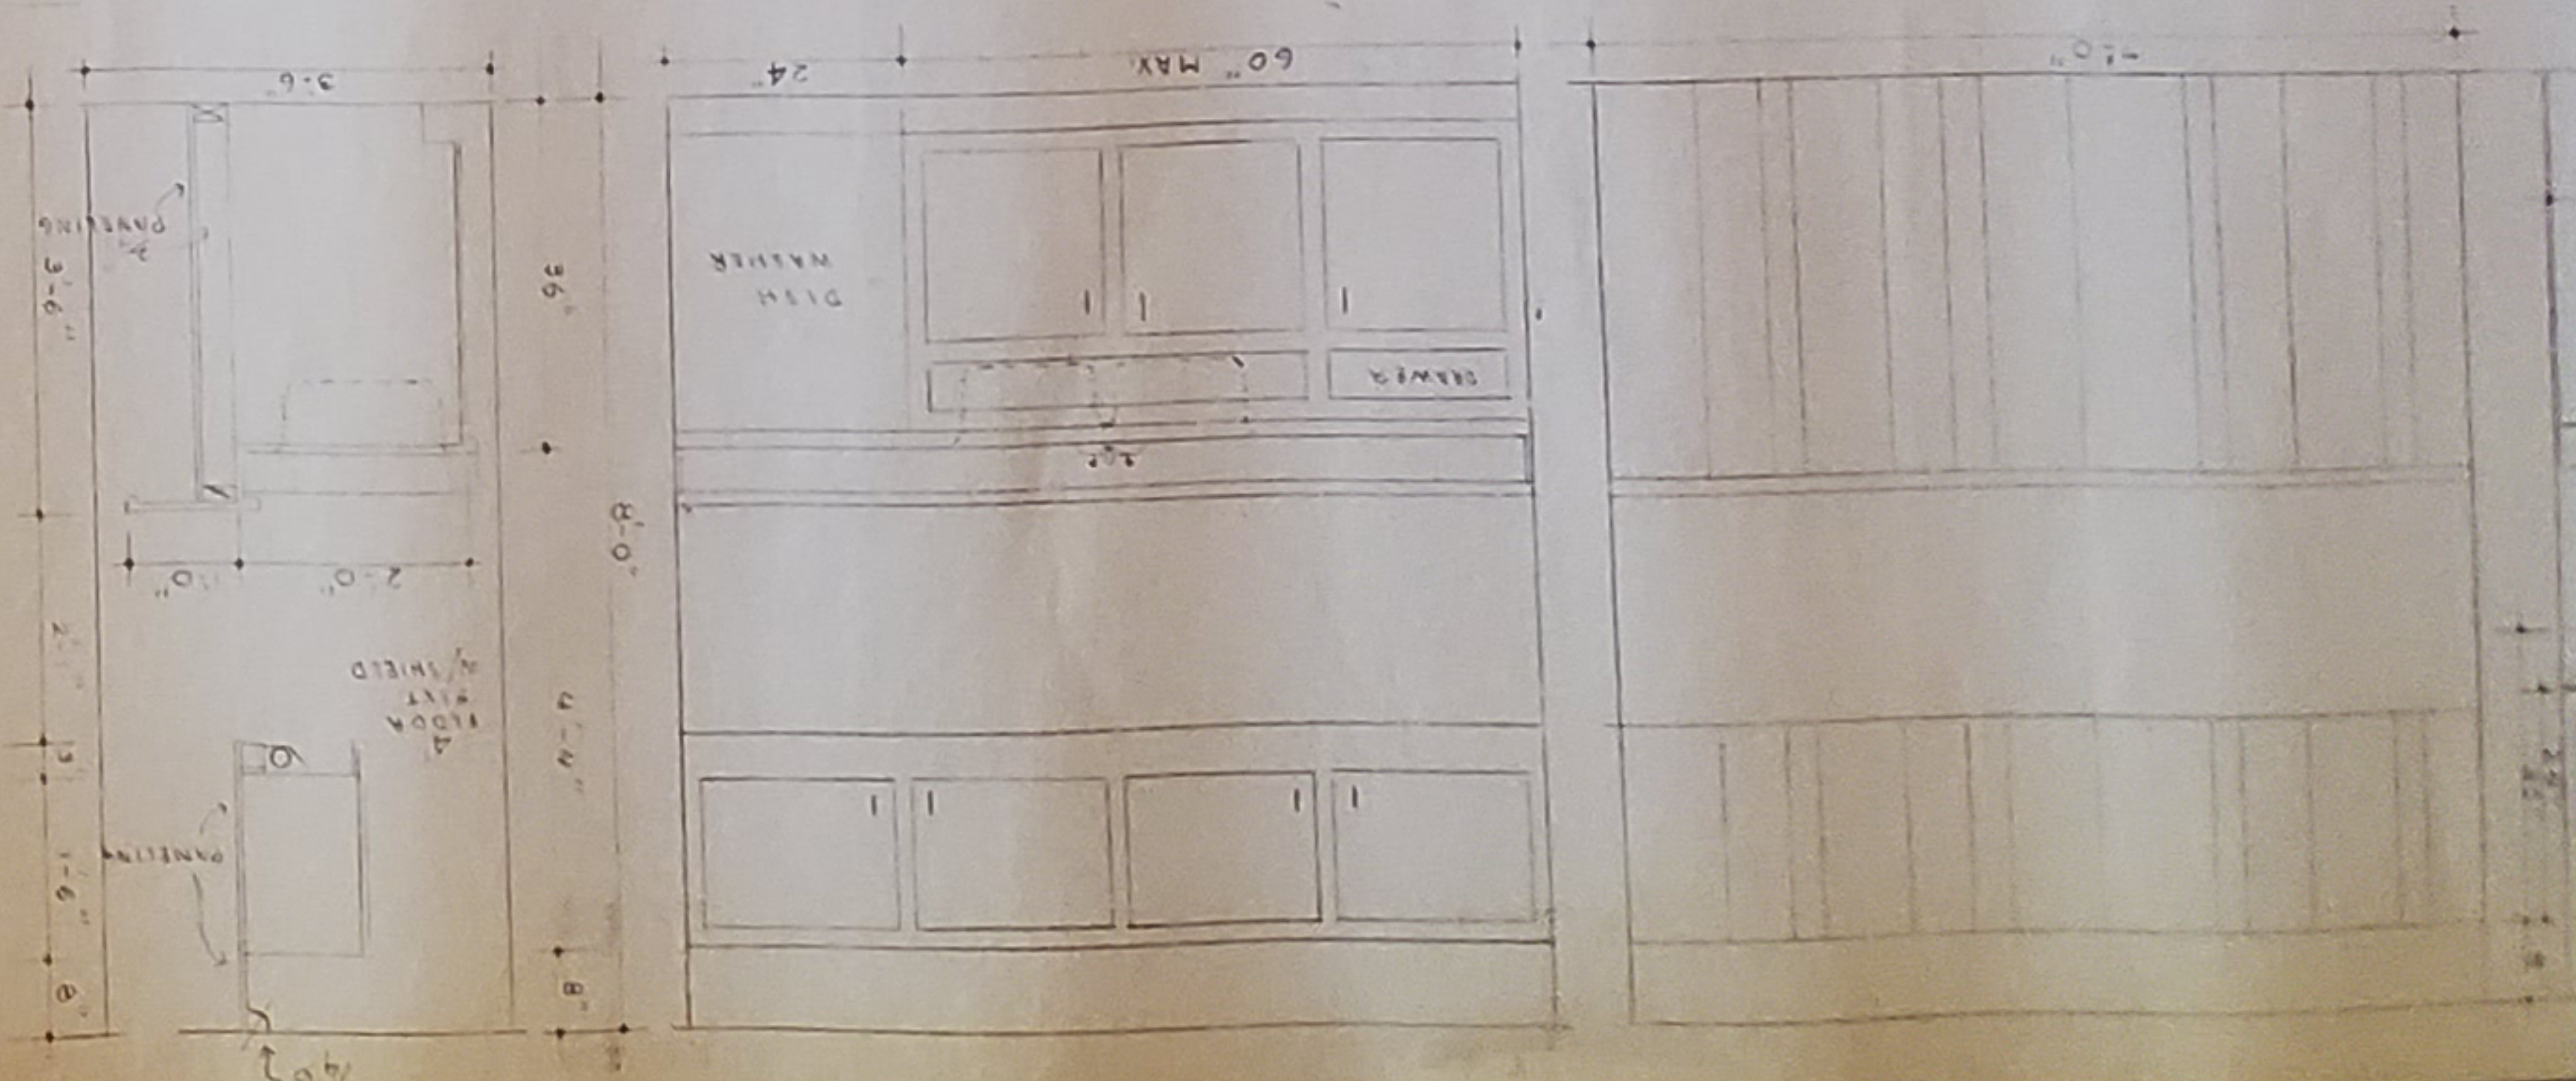

ABBREVIATIONS & SYMBOLS


IN.	INCH
INT.	INTERIOR
INSUL.	INSULATION
I.D.	INSIDE DIAMETER
L.DY.	LAUNDRY
MAX.	MAXIMUM
M.H.	MANNHOLE
M.C.	MEDICINE CABINET
MIN.	MINIMUM
M.I.C.	NOT IN CONTRACT
M.T.S.	NOT TO SCALE
O.C.	ON CENTER
OP.	OPPOSITE
O.O.	OUTSIDE TO OUTSIDE
O.P.S.	OPENING
PLM.	PLYWOOD
PLATE	PLATE
P.S.F.	POUNDS PER SQUARE FOOT
P.S.I.	POUNDS PER SQUARE INCH
R.	THERMAL RESISTANCE
R.S.	ROUGH SAWS
S.	SOIL
SAN.	SANITARY
SEC.	SECTION
S.C.	SOLID CORE
STOR.	STORAGE
S.F.	SQUARE FEET
S.T.C.	SOUND TRANSMISSION CLASS
STD.	STUD
SHT.	SHEET
SHING.	SHINGLING
TH.	THICKNESS
PH.	PHYSICAL
TR.	TOWER BAR
TEMP.	TEMPERATURE
U.O.S.	USABLE OPEN SPACE
V.	VENT
V.T.	VINYL TILE
W.D.	WOOD
M.M.	WELD WIRE MESH
M.I.	WROUGHT IRON

MODERN CONSTRUCTION HANDBOOK
 Andrew Walls Sixth Edition

Specifying Interiors
 A Guide to Construction and
 FF&E for Residential and
 Commercial Interiors Projects
 Second Edition
 McGraw-Hill



FRONT & REAR ELEVATIONS (SEE SH 13 FOR REAR OF B-4)
1/8" = 1'-0"

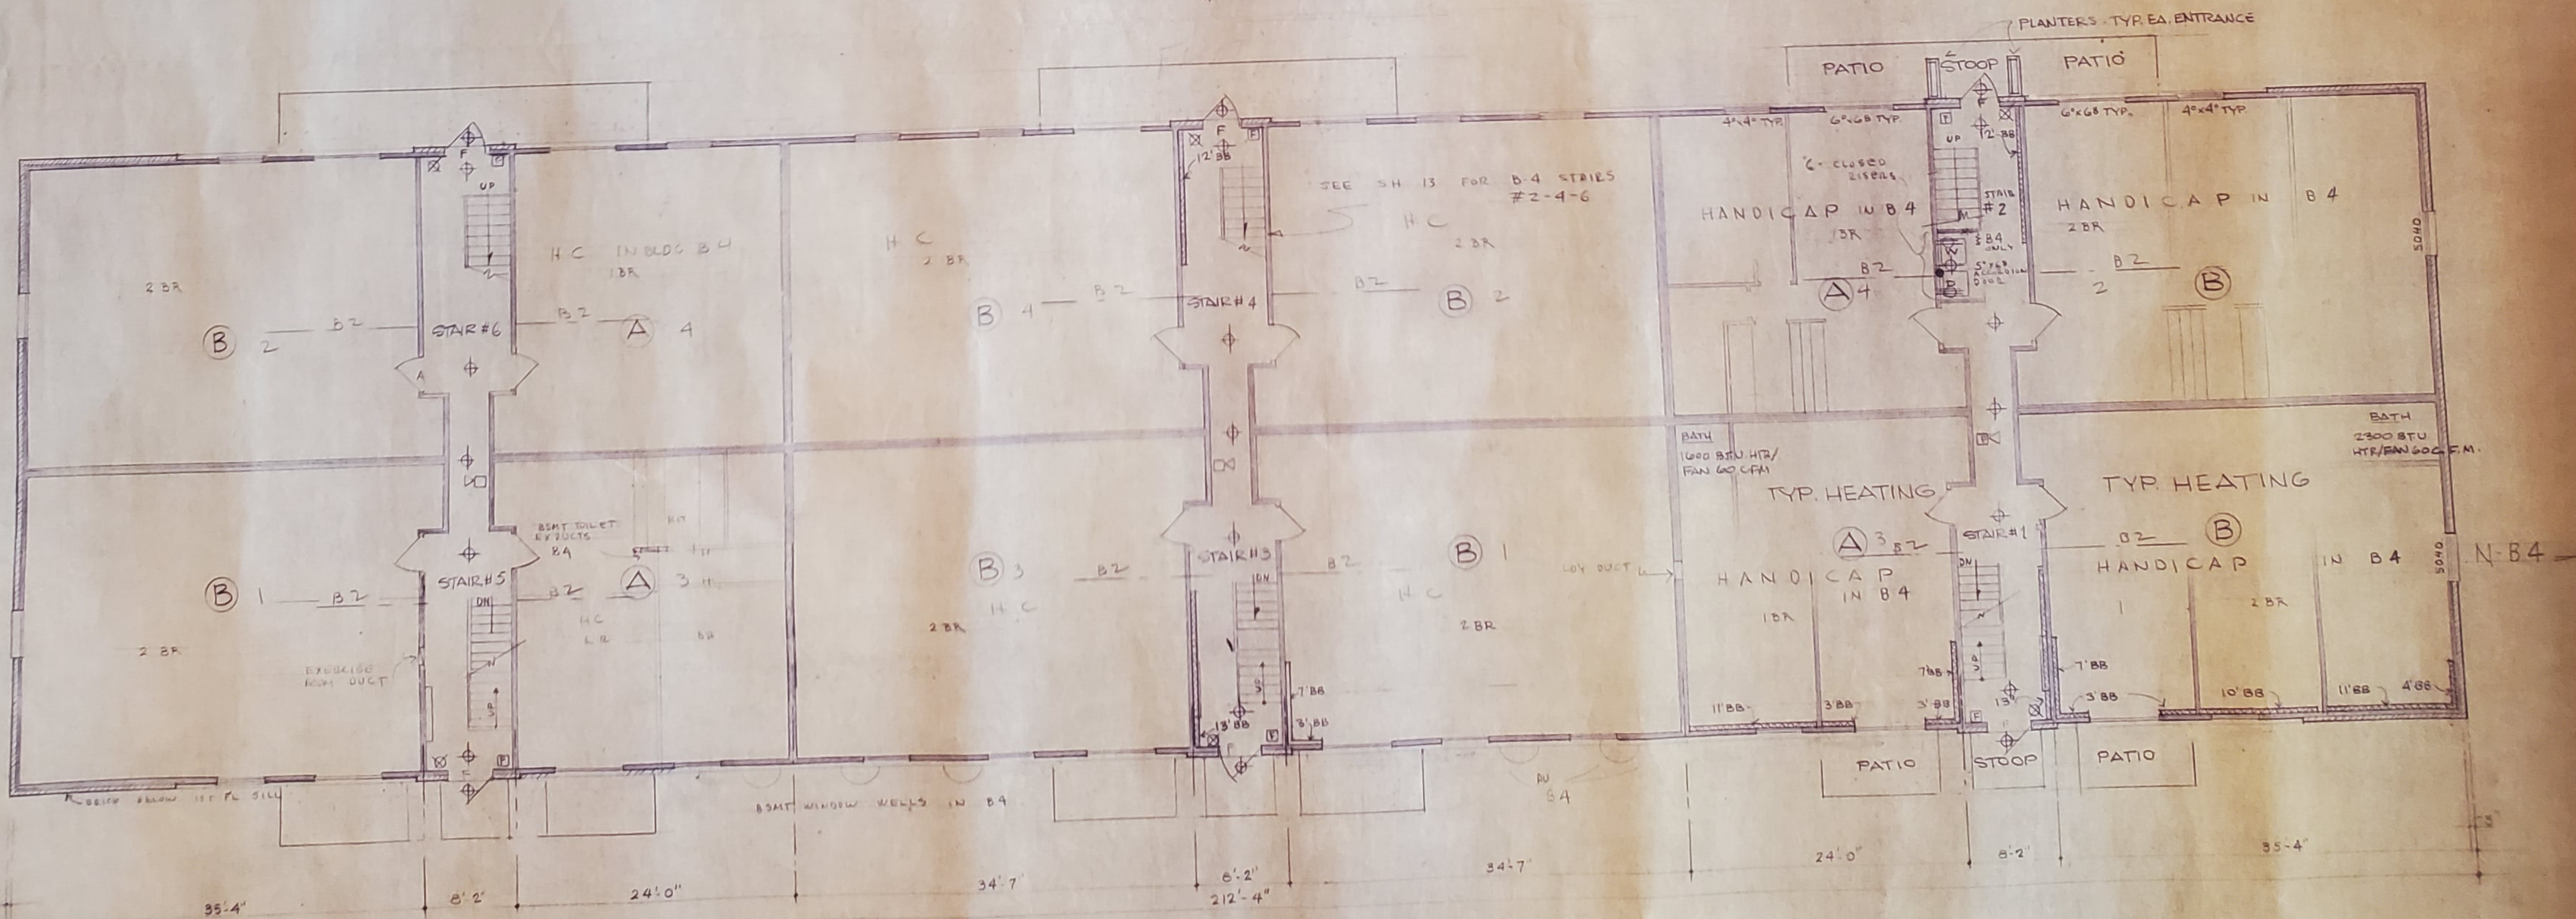

FIRST FLOOR PLAN
1/8" = 1'-0"